

# **Application for change or cancellation of resource consent condition (S.127)**

(Or Associated Consent Pursuant to the Resource Management Act 1991 (RMA)) Prior to, and during, completion of this application form, please refer to Resource Consent Guidance Notes and Schedule of Fees and Charges — <u>both available on the Council's web page</u>.

#### **1. Pre-Lodgement Meeting**

Have you met with a council Resource Consent representative to discuss this application prior to lodgement?

If yes, who have you spoken with? <u>Salamasina Brown</u>, Rinku Mishra, Smitha Bhaskar

#### 2. Type of Consent being applied for

Change of conditions (s.127)

#### **3. Consultation:**

Have you consulted with lv	vi/Hapū? 🔵 Yes 🔘 No	
If yes, which groups have you consulted with?		
Who else have you consulted with?		

For any questions or information regarding iwi/hapū consultation, please contact Te Hono at Far North District Council tehonosupport@fndc.govt.nz

#### 4. Applicant Details:

Name/s:	Esnem Properties Ltd
Email:	
Phone number:	
<b>Postal address:</b> (or alternative method of service under section 352 of the act)	
Office Use Only Application Number:	

#### 5. Address for Correspondence

Name and address for service and correspondence (if using an Agent write their details here)

Name/s:	Shane Tregidga
Email:	
Phone number:	
<b>Postal address:</b> (or alternative method of service under section 352 of the act)	

All correspondence will be sent by email in the first instance. Please advise us if you would prefer an alternative means of communication.

#### 6. Details of Property Owner/s and Occupier/s

Name and Address of the Owner/Occupiers of the land to which this application relates (where there are multiple owners or occupiers please list on a separate sheet if required)

Name/s:

**Property Address/** Location:

Esnem Properties Ltd		_
242 Pouto Rd, Dargaville, Northland		
	Postcode	0371

#### **7. Application Site Details**

Location and/or property street address of the proposed activity:

Name/s:			
Site Address/ Location:	6 Bisset Road, Kaikohe, Northland		
		Postcode	0405
Legal Description:	Lot 1 DP 584828	Val Number: 00523-20801	
Certificate of title:	1101253		

Please remember to attach a copy of your Certificate of Title to the application, along with relevant consent notices and/or easements and encumbrances (search copy must be less than 6 months old)

#### Site visit requirements:

Is there a locked gate or security system restricting access by Council staff? ()Yes ()No



Is there a dog on the property?  $\bigcirc$  Yes  $\checkmark$  No

#### 7. Application Site Details (continued)

Please provide details of any other entry restrictions that Council staff should be aware of, e.g. health and safety, caretaker's details.

This is important to avoid a wasted trip and having to re-arrange a second visit.

No	restrictions
110	1000110110110

#### 8. Detailed description of the proposal:

This application relates to the following resource consent:

Specific conditions to which this application relates:

2300042-RMAVAR/A

Subdivision

Describe the proposed changes:

Proposing to split 6 Bisset Rd property into 2 Lots (as previously approved as part of - RC 2300042). Proposed footprint for potential future medium density development on 4 Timatanga Place property.

#### 9. Would you like to request Public Notification?

Yes 🗸 No

#### 10. Other Consent required/being applied for under different legislation

(more than one circle can be ticked):

Building Consent Enter BC ref # here (if know	n)
Regional Council Consent (ref # if known)	Ref # here (if known)
ONational Environmental Standard consen	t Consent here (if known)
Other (please specify) Specify 'other' here	

#### **11. Assessment of Environmental Effects:**

Every application for resource consent must be accompanied by an Assessment of Environmental Effects (AEE). This is a requirement of Schedule 4 of the Resource Management Act 1991 and an application can be rejected if an adequate AEE is not provided. The information in an AEE must be specified in sufficient detail to satisfy the purpose for which it is required. Your AEE may include additional information such as Written Approvals from adjoining property owners, or affected parties (including consultation from iwi/hapū).

Your AEE is attached to this application 🖌 Yes

#### **12. Draft Conditions:**

Do you wish to see the draft conditions prior to the release of the resource consent decision? **Yes** 

If yes, do you agree to extend the processing timeframe pursuant to Section 37 of the Resource Management Act by 5 working days? **Yes No** 

#### **13. Billing Details:**

This identifies the person or entity that will be responsible for paying any invoices or receiving any refunds associated with processing this resource consent. Please also refer to Council's Fees and Charges Schedule.

Name/s: (please write in full)	Esnem Properties Ltd
--------------------------------	----------------------

#### **Email:**

#### Phone number:

#### **Postal address:**

(or alternative method of service under section 352 of the act)

#### **Fees Information:**

An instalment fee for processing this application is payable at the time of lodgement and must accompany your application in order for it to be lodged. Please note that if the instalment fee is insufficient to cover the actual and reasonable costs of work undertaken to process the application you will be required to pay any additional costs. Invoiced amounts are payable by the 20th of the month following invoice date. You may also be required to make additional payments if your application requires notification.

#### **Declaration concerning Payment of Fees:**

I/we understand that the Council may charge me/us for all costs actually and reasonably incurred in processing this application. Subject to my/our rights under Sections 357B and 358 of the RMA, to object to any costs, I/we undertake to pay all and future processing costs incurred by the Council. Without limiting the Far North District Council's legal rights if any steps (including the use of debt collection agencies) are necessary to recover unpaid processing costs I/we agree to pay all costs of recovering those processing costs. If this application is made on behalf of a trust (private or family), a society (incorporated or unincorporated) or a company in signing this application I/we are binding the trust, society or company to pay all the above costs and guaranteeing to pay all the above costs in my/our personal capacity.

Name: (please write in full)	Shane Tregidga (Director)	1					,
Signature: (signature of bill payer				Date	13/1	12/	24
			MANDATORY		1		
			•				

Form 10 Application for change or cancellation of resource consent condition 4

No

#### 14. Important Information:

#### Note to applicant

You must include all information required by this form. The information must be specified in sufficient detail to satisfy the purpose for which it is required.

You must pay the charge payable to the consent authority for the resource consent application under the Resource Management Act 1991.

#### **PrivacyInformation:**

Once this application is lodged with the Council it becomes public information. Please advise Council if there is sensitive

information in the proposal. The information you have provided on this form is required so that your application for consent pursuant to the Resource Management Act 1991 can be processed under that Act. The information will be stored on a public register and held by the Far North District Council. The details of your application may also be made available to the public on the Council's website, www. fndc.govt.nz. These details are collected to inform the general public and community groups about all consents which have been issued through the Far North District Council.

#### Declaration

The information I have supplied withthis application is true and complete to the best of my knowledge.

Name: (please write in full)	Shane Tregidga		/	_		,	,
Signature:					Date	13/12/	24
	A signature is not requir	ea ij toe applicatioi	i is maae by eie	ctronic means			

#### **Checklist (please tick if information is provided)**

Payment (cheques payable to Far North District Council)

Details of your consultation with lwi and hapū

A current Certificate of Title (Search Copy not more than 6 months old)

Copies of any listed encumbrances, easements and/or consent notices relevant to the application

Applicant / Agent / Property Owner / Bill Payer details provided

Location of property and description of proposal

Assessment of Environmental Effects

Written Approvals / correspondence from consulted parties

Reports from technical experts (if required)

Copies of other relevant consents associated with this application

🖌 Location and Site plans (land use) AND/OR

🖌 Location and Scheme Plan (subdivision)

Elevations / Floor plans

Topographical / contour plans


Please refer to chapter 4 (Standard Provisions) of the Operative District Plan for details of the information that must be provided with an application. This contains more helpful hints as to what information needs to be shown on plans.

Sheet Index			
Layout ID	Layout Name		Issue ID
RC01	Cover Sheet	K	
RC02	Site: FNUP Compliance Schedule	К	
RC03	Site Bulk & Location	K	
RC04	Vehicle Tracking/Landscape Plan & Critical Point Sections	K	
RC05	Proposed Scheme Plan	К	

# 6 Bisset Road, Kaikohe

**RC Variation Application** 



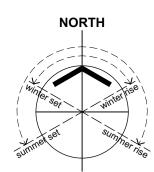

## **GENERAL NOTES**

0.1 Contractor to verify all dimensions and condition on site before commencing work.
0.2 Work only from figured dimensions. In the even a discrepancy consult the Architect.
0.3 The drawings are to be read in conjunction with Specification.
0.4 If in doubt, consult the Architect.

RevID	ChID	Revision	Date
А			22/07/2020
В	B-01	Boundary Setout plan added to set	19/08/2020
С			27/08/2020
D	D-05	Issue Schedule updated	11/09/2020
к			24/11/2024

P. 021 250 6671 E. esnempropertiesltd@gmail.com

title Esnem Properties Ltd

Proposed Subdivision 6 Bisset Road Kaikohe Northland sheet title

**RC Submission Cover Sheet** 

drawn ST


scale As marked at A1 sheet no.

**RC01** 


printed Sunday, 8 December 2024 RC Variation #2

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L	PERMITTED	ADDITIONAL INFO	6 Bisset Rd	8 Timatanga Pl	6 Timatanga Pl	4 Timatanga Pl	LOT 5
					11		
ight	8m		complies	complies	complies	ТВС	complies
	2m + 45deg	neighbour / external	complies	complies	complies	твс	Restricted Discretionary
<i>r</i> ious Area compliant	60% 1,524.6	Site Area Impervious Area Percentage	796.7 367.6 46.1%	completed 183.7 47.4%	330.8 173.9 52.5%	TBC (future development)	266.8 123.6 46.3%
backs	road 3m		complies	complies	complies	твс	complies
g Coverage compliant	45% 1,143.5	Site Area Building Coverage Percentage	796.7 92.8 11.6%	387.2 92.7 23.9%	330.8 92.7 28.0%	ТВС	266.8 approx. 90 33.7%
	<u> </u>	. this drawing and the design it covers shall remain the prop	erty and copyright of the Architects .				

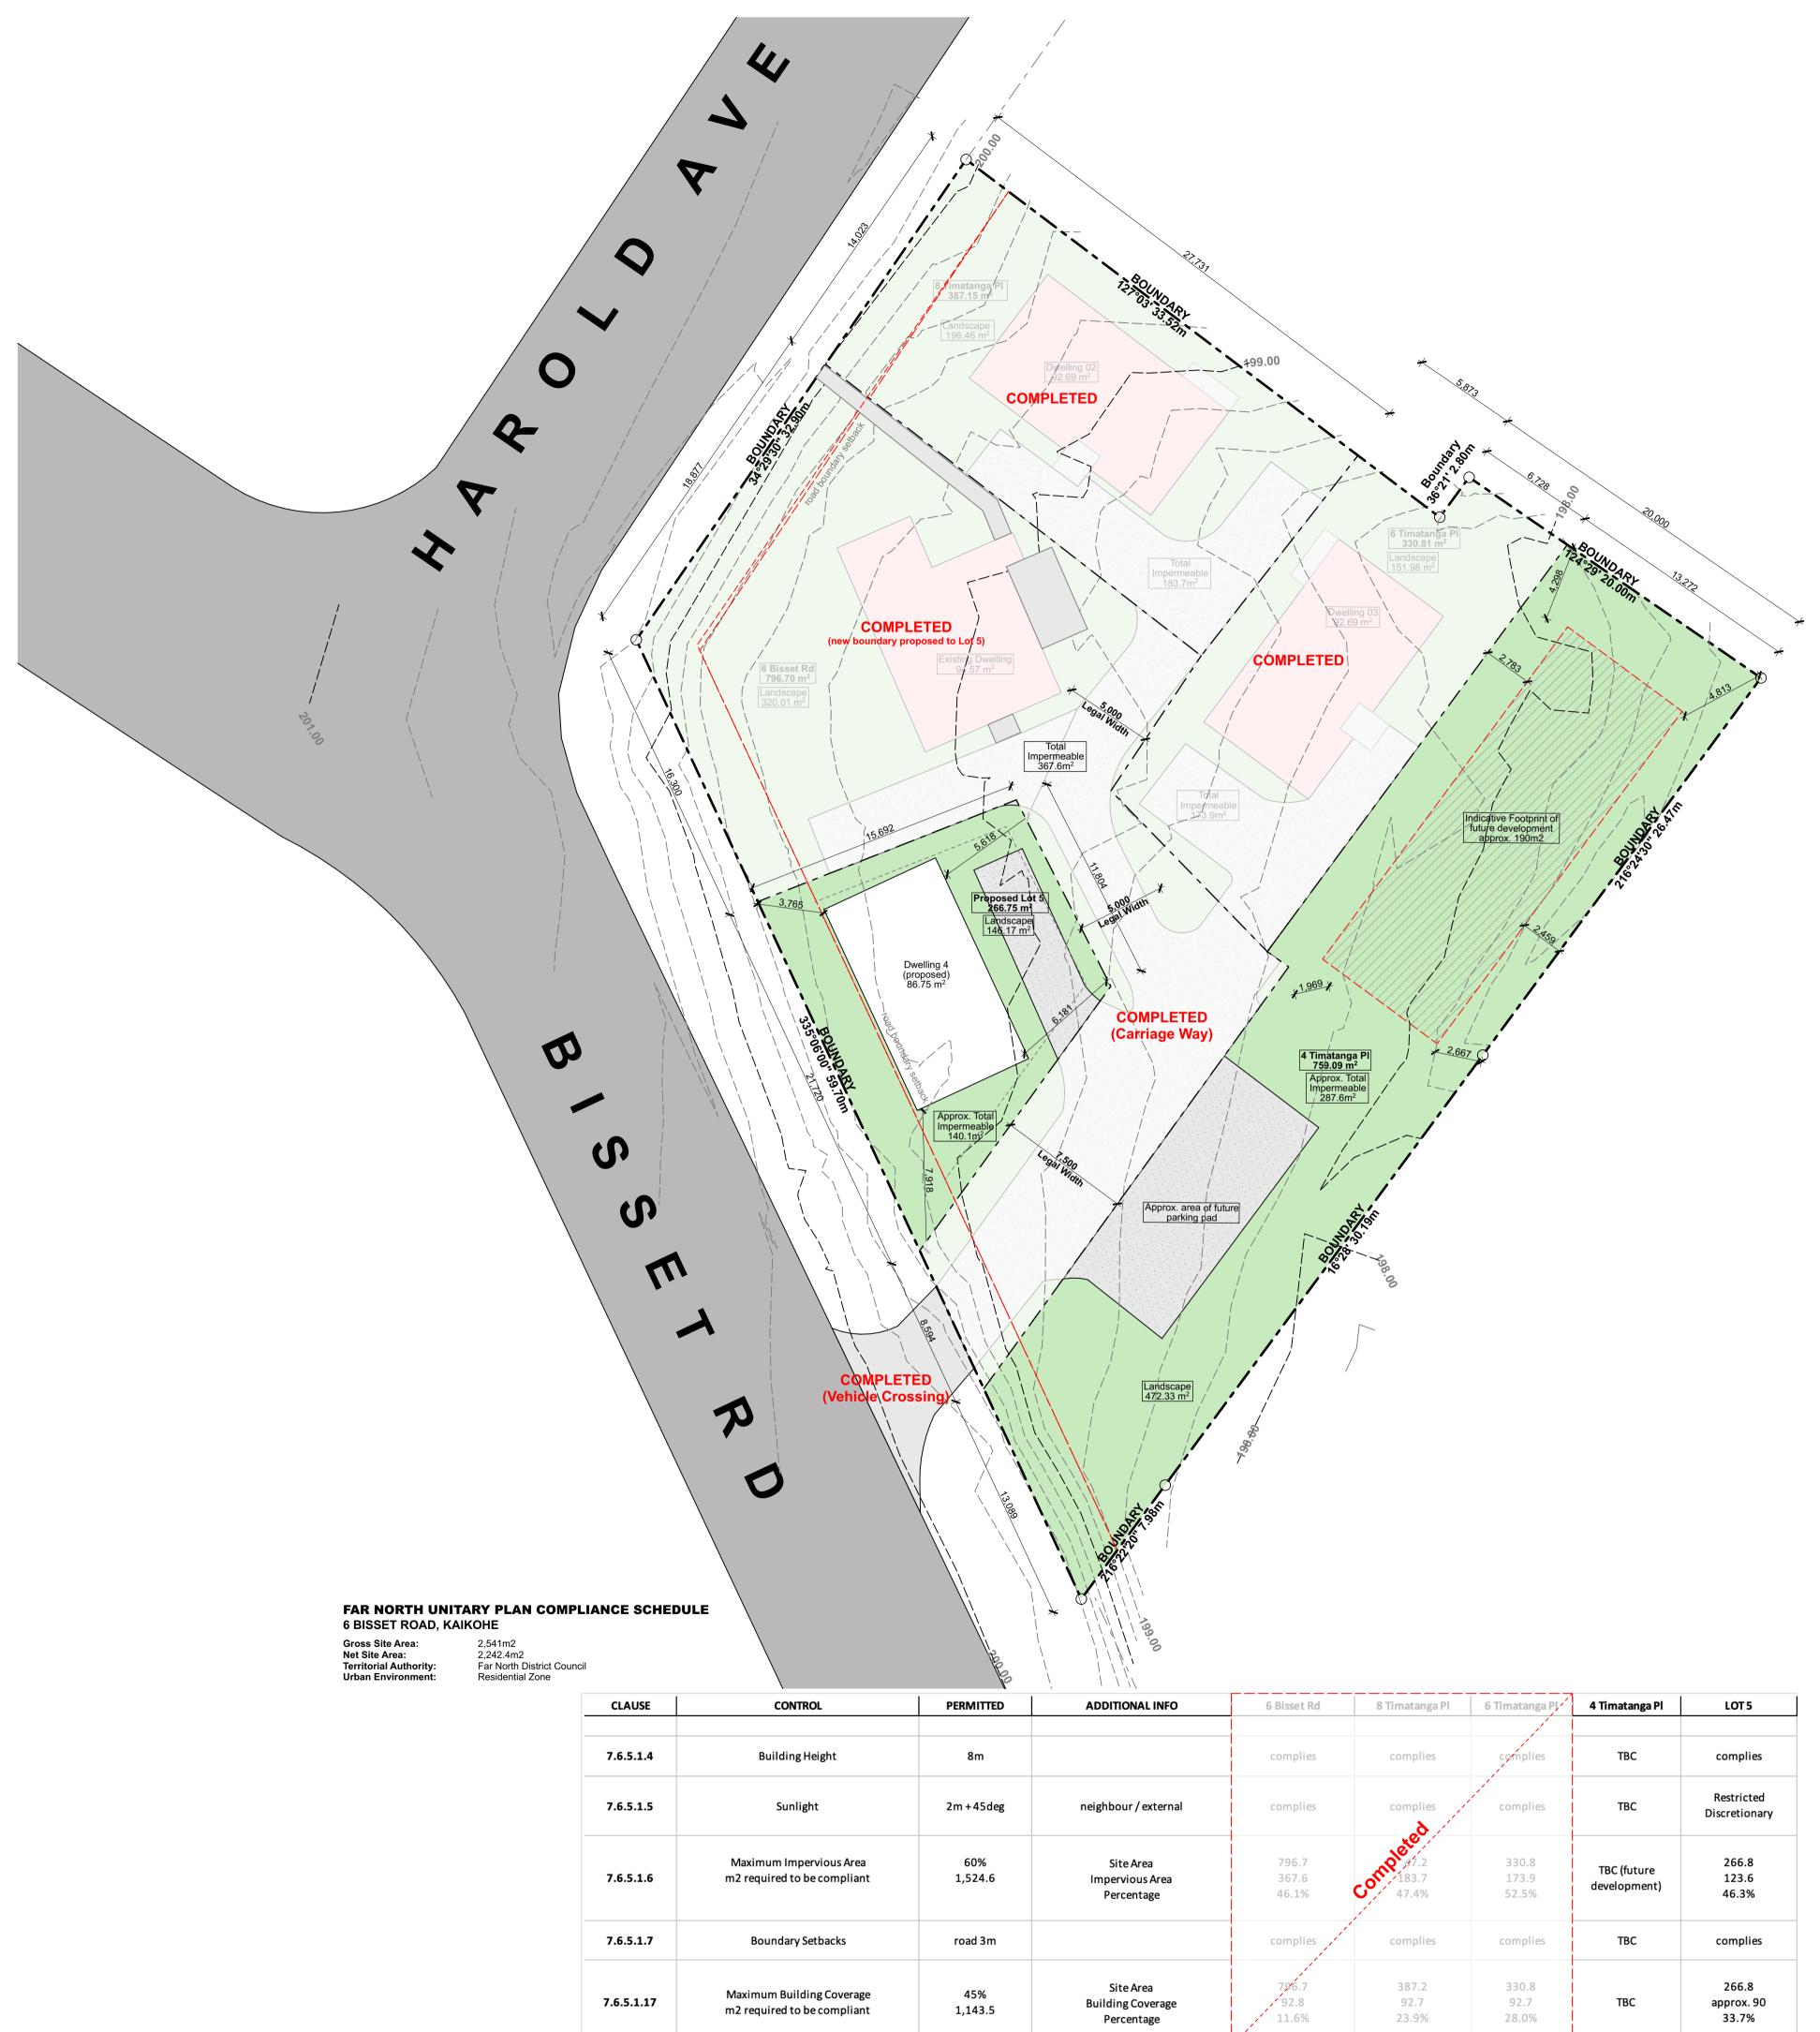

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0.4 If is doubt consult the Architect

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#### **DEVELOPMENT CONTROLS:**

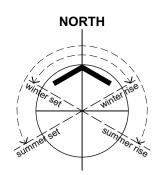Legal Description: Lot 2 DP 161706 CT: NA97C/58 Area: 2,541m<sup>2</sup> FNDC Local Authority: FNDC Environment: Max. Building Height: Building Coverage: Impermeable Coverage: Boundary Setbacks:


Residential Zone 8.0m max. 45% max. 60% max. 3.0m road Bdy

#### SITE DESIGN INFORMATION:


Wind Zone = Earthquake Zone = Exposure Zone = Rainfall Intensity =

MEDIUM Zone 1 Zone B <u>80 - 90mm/hr</u>

#### BULK & LOCATION LEGEND:

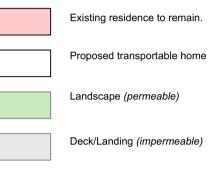

Deck/Landing (impermeable)

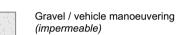

Indicative coverage of unconfirmed future development

	RevID	ChID	Revision	Date
	А			22/07/2020
	D	D-01	Carriageway updates / boundary adjustments	11/09/2020
		D-02	Compliance Schedule Updated	11/09/2020
		D-05	Issue Schedule updated	
	к			24/11/2024

P. 021 250 6671 E. esnempropertiesItd@gmail.com

title Esnem Properties Ltd

## **Proposed Subdivision** 6 Bisset Road

Kaikohe Northland sheet title

## **RC Submission** Site: FNUP Compliance Schedule

drawn ST

scale As marked at A1 sheet no.


RC02

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issue

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50mm

**6 BISSET ROAD - AUP COVERAGE CALCULATIONS** 

Site: Bulk and Location (context)

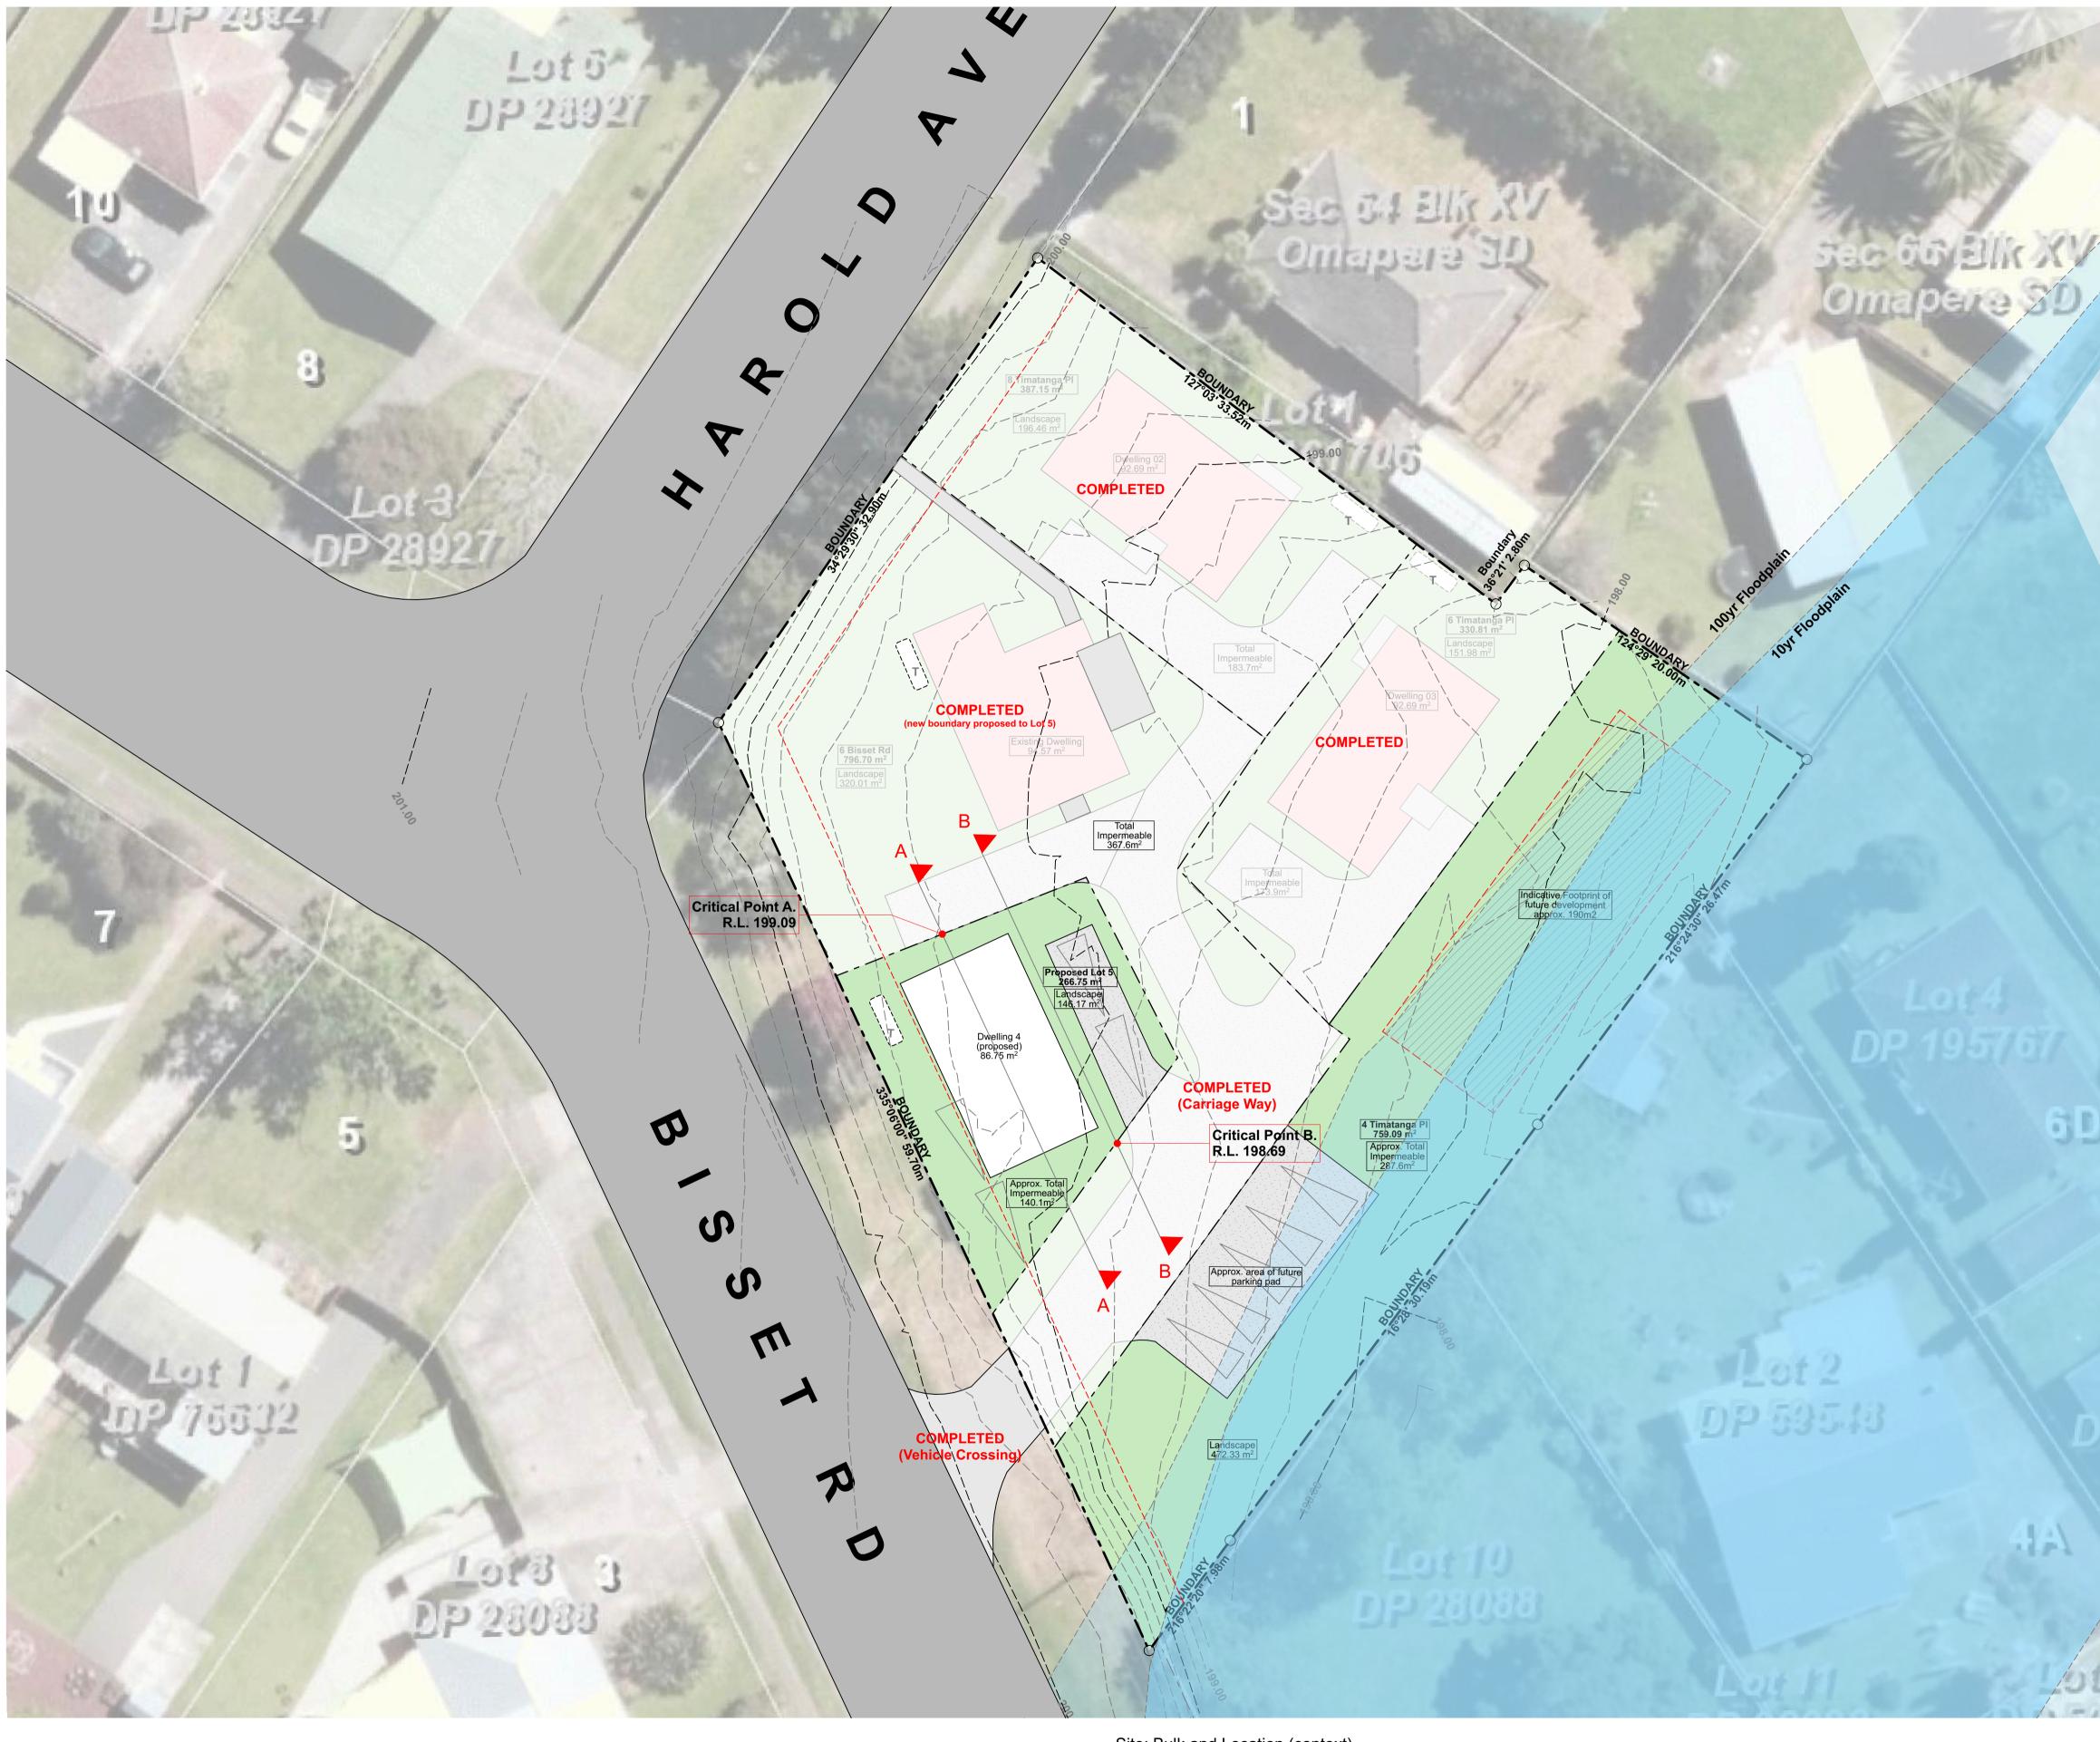Site Area

Impervious: Landscaped Area:

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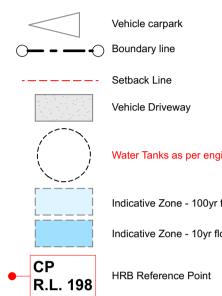
## **GENERAL NOTES**

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## **BULK & LOCATION LEGEND:**

Existing residence to remain.
Proposed transportable home
Landscape (permeable)
Deck/Landing (impermeable)
Gravel / vehicle manoeuvering (impermeable)
Indicative coverage of unconfirmed future development

## SITE PLAN LEGEND:



Setback Line	
Vehicle Driveway	

#### Water Tanks as per engineer design.

Indicative Zone - 100yr flood event Indicative Zone - 10yr flood event

RevID	ChID	Revision	Date
Revid	ChiD	Revision	Date
Α			22/07/2020
D	D-01	Carriageway updates / boundary adjustments	11/09/2020
	D-03	Coverage Calculations updated	
к			24/11/2024

P. 021 250 6671 E. esnempropertiesltd@gmail.com

**Esnem Properties Ltd** 

## **Proposed Subdivision** 6 Bisset Road

Kaikohe Northland sheet title **RC Submission** 

Site Bulk & Location

drawn ST

1:200

title

scale As marked at A1

sheet no. RC03

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issue

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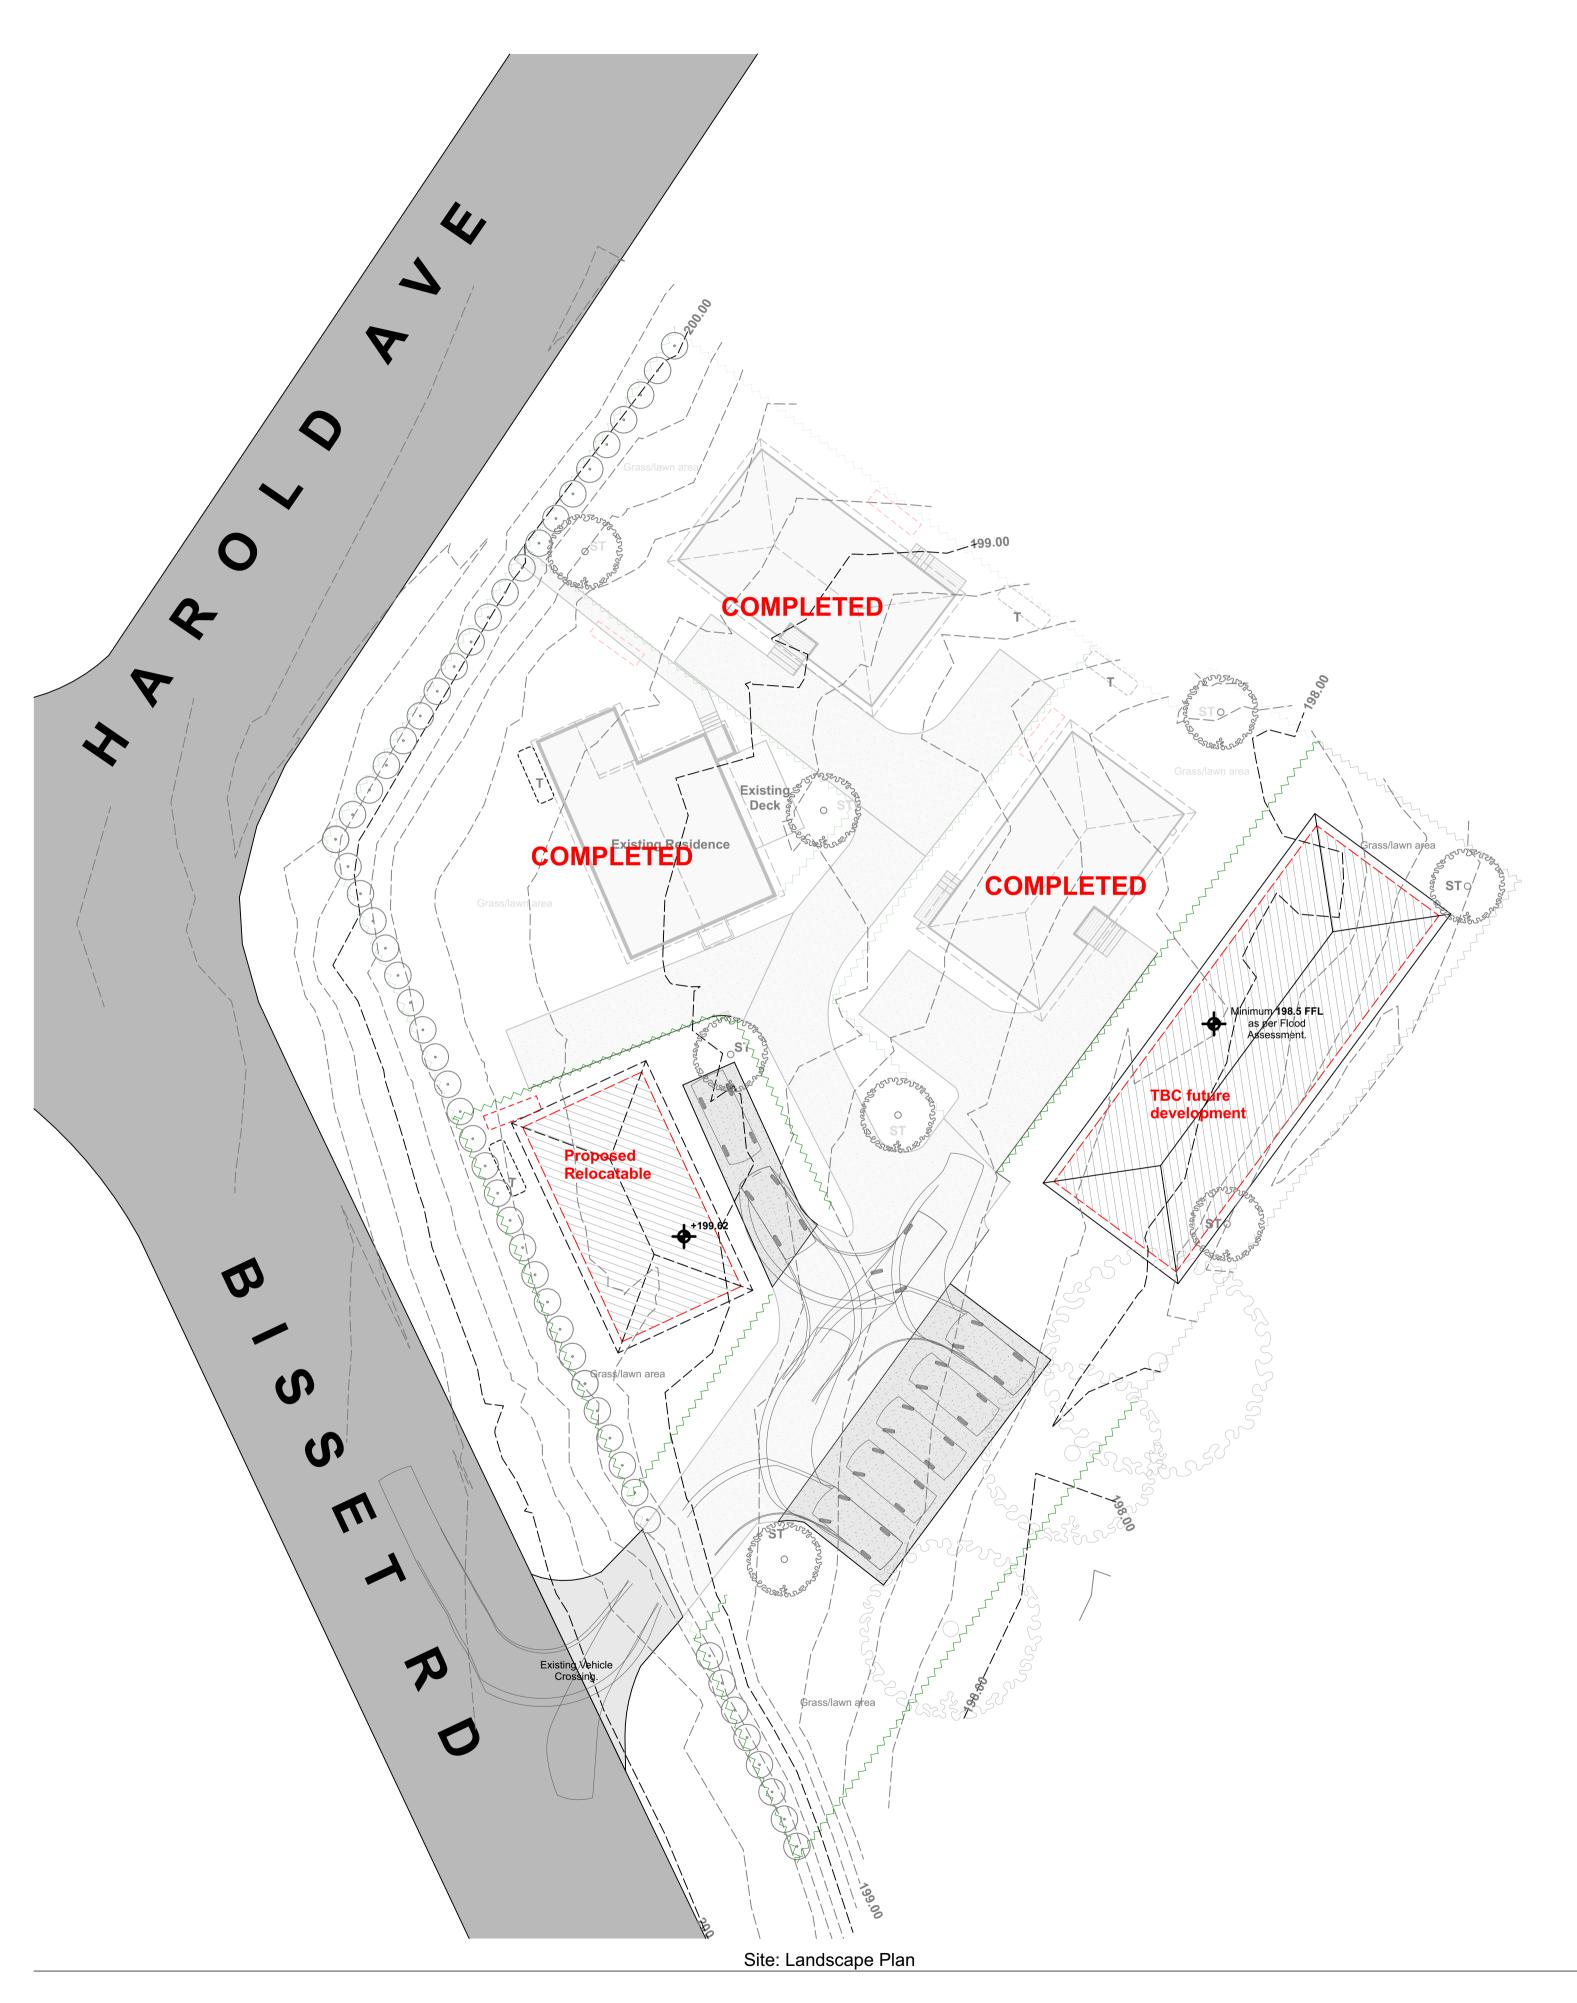
2,541m2


**Building Coverage** 

approx. 563m2 approx. 1,206m2 approx. 1,338m2

60


AUP Compliance 22.1% (<45% required) 47.4% (<60% required)



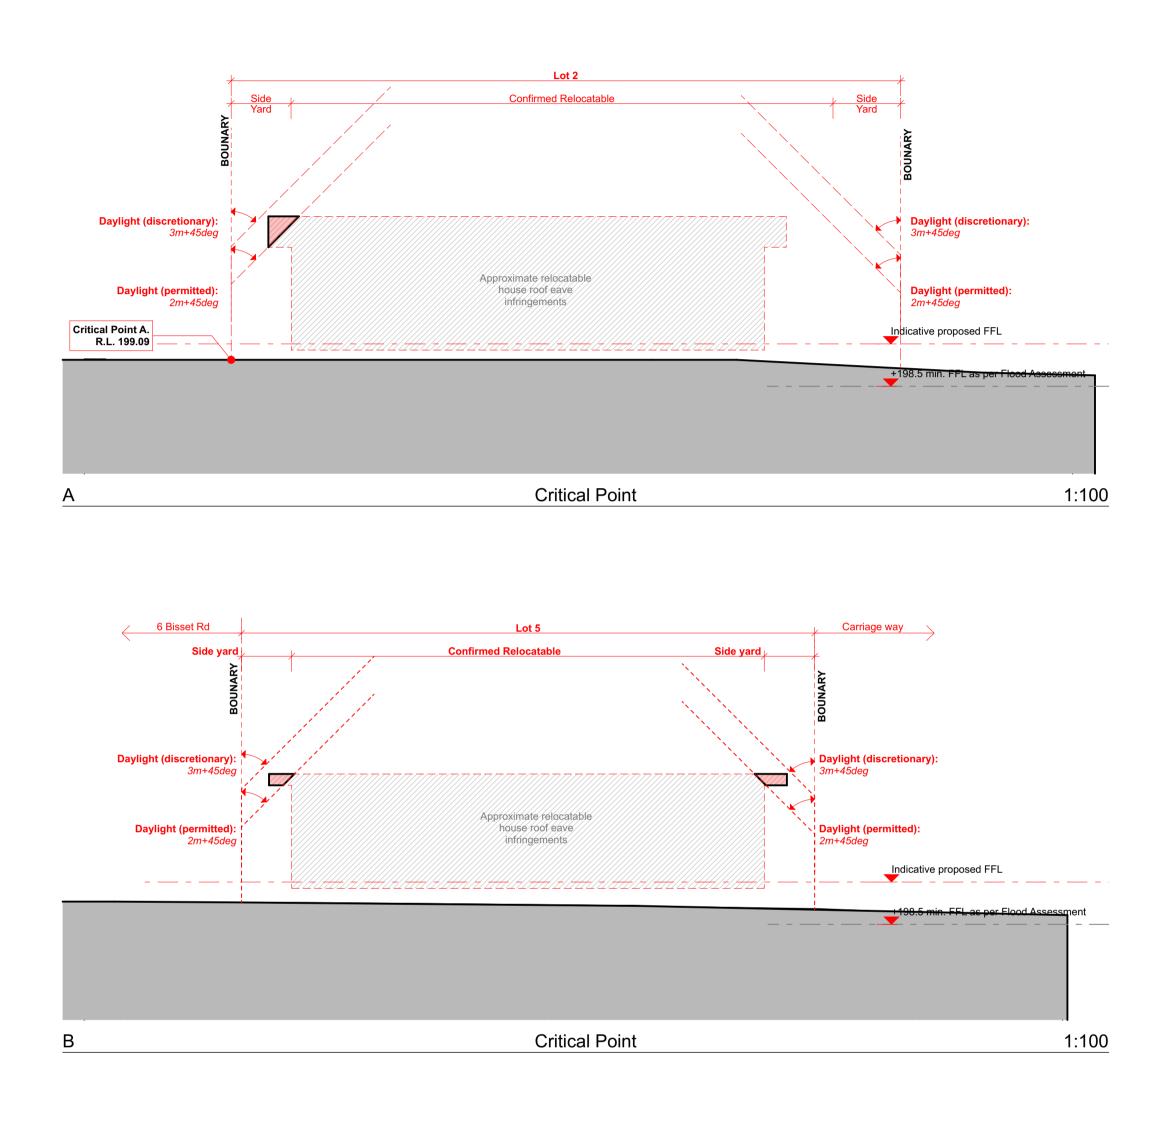

1:200

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## **GENERAL NOTES**
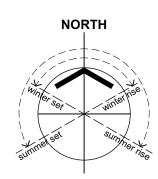
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## LANDSCAPE PLAN LEGEND:

	Vehicle Driveway
:	5000L Water Tanks as Stormwater Assessment.
ST	Proposed Specimen Tree
•	Proposed pittosporum hedge along road boundaries.
~~~~~~	Existing timber fences to remain.
~~~~~~	Proposed timber fencing
[]	Indicative washing line zone

RevID	ChID	Revision	Date
А			22/07/2020
D	D-01	Carriageway updates / boundary adjustments	11/09/2020
	D-04	Section C updated	
К			24/11/2024

P. 021 250 6671 E. esnempropertiesltd@gmail.com

title Esnem Properties Ltd

## **Proposed Subdivision** 6 Bisset Road

Kaikohe Northland sheet title

## **RC Submission** Vehicle Tracking/

Landscape Plan & **Critical Point Sections** ST

scale As marked at A1


RC Variation #2

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issue Κ



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## **GENERAL NOTES**

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0.4 If in doubt, consult the Architect.
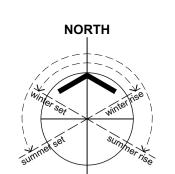
## Schedule / Memorandum

Land Registration District	Plan Number
North Auckland	DP 584828
Territorial Authority (the Council)	Council Reference
Far North District Council	2300042-RMAVAR/A

Memorandum of Easements Pursuant to s243 Resource Management Act 1991				
Purpose	Shown	Burdened Land (Servient Tenement)	Benefitted Land (Dominant Tenement)	
Right of Way and Right to Convey	A & B	Lot 1 DP 584828	Lots 2, 3 & 4 DP 584828	
Electricity & Telecommunications	С	Lot 1 DP 584828	Lot 2 DP 584828	
	А	Lot 1 DP 584828	Lots 3 & 4 DP 584828	
Dight to Convey Weter	D	Lot 3 DP 584828	Lot 4 DP 584828	
Right to Convey Water	E	Lot 4 DP 584828	Lot 3 DP 584828	
	н	Lot 1 DP 584828	Lot 2 DP 584828	
Right to Drain Sewage	к	Lot 1 DP 584828	Lot 2 DP 584828	
Right to Drain Water & Sewage	J	Lot 1 DP 584828	Proposed new Lot	

Memorandum of Easements in Gross Pursuant to s243 Resource Management Act 1991				
Purpose	Shown	Burdened Land (Servient Tenement)	Grantee	
	A, B & C	Lot 1 DP 584828		
Right to Drain Water & Sewage	D	Lot 3 DP 584828		
	E	Lot 4 DP 584828	Far North District Council	
Diabit to Duoin Maton	F	Lot 3 DP 584828	Far North District Council	
Right to Drain Water	I	Lot 4 DP 584828		
Right to Drain Sewage	G	Lot 3 DP 584828		
Right to Convey Telecommunications	L	Lot 2 DP 584828	Chorus New Zealand Ltd	
Right to Drain Water & Sewage	J	Lot 1 DP 584828	Far North District Council	

Date
19/08/2020
27/08/2020
11/09/2020
24/11/2024

P. 021 250 6671 E. esnempropertiesltd@gmail.com

title Esnem Properties Ltd

## **Proposed Subdivision** 6 Bisset Road

Kaikohe Northland sheet title

**RC Submission** Proposed Scheme Plan

drawn ST

scale As marked at A1 sheet no.

RC05

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issue

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## **Document Information**

Client:	Esnem Properties Ltd
Title:	6 Bisset Road Development Assessment of Environmental Effects for Resource Consent Combined Subdivision & Land Use Application
Address:	6 Bisset Road, Kaikohe Northland


- Prepared by: Esnem Properties Ltd
- Date: 24 Nov 2024





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4.	Assessment of Environmental Effects 7			
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6.	Notes from FNDC District Plan 1			
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8.	Supporting Documents (uploaded to FNDC Portal)			
	8.1 8.2 8.3	Pre-Application Meeting Minutes AEE Assessment District Plan Table Records of Title		



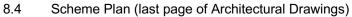

ESNEM PROPERTIES LIMITED

## 1. Site Description

Site Location:	6 Bisset Road, Kaikohe, Northland
Legal Description:	Lot 2 DP 16176
Certificate of Title:	NA97C/58
Site Area:	2,541m2
Relevant Plans:	Far North District Plan
Zone:	Residential Zone

The site is located approximately 1 kilometer from Kaikohe town center. It is a large, corner site which contains one existing residence and single garage. The topography of the site slopes slightly towards the South East boundary. Along the South East boundary there is partial flood plain infringement (as commented on in Flood Assessment). Surrounding context is residential.





## 2. Work Proposal

#### Background:

The original subdivision was approved to create six new Lots (RC 2300042, stamped 15/9/2020). Due to staging challenges, a variation was submitted and subsequently approved to reduce the subdivision to four Lots, which has since been completed. Certificates 223 and 224c were issued 27/3/2023.

#### Variation:

This proposal seeks a minor variation to the previously approved resource consent. The variation includes the following:

#### 1. Creation of an Additional Lot (Lot 5):

• The proposal involves creating a new Lot, identified as Lot 5 in the accompanying drawings.

#### 2. Relocatable Housing for Lot 5:

• A 3 Bed 1 Bath relocatable house, consistent in quality and process with those completed in Stage 1, is proposed to be delivered to Lot 5.

#### 3. Medium-Density Development Concept for 4 Timatanga Place (Future Proposal):

- A tentative concept for a medium-density development is proposed, which may include either a duplex or a small block of 2-3 ground-level flats.
- This proposal outlines the general footprint required for such development, including the approximate location for the building and associated parking.

The original resource consent allowed for six standalone dwellings. If a duplex is constructed in the future (on 4 Timatanga PI), the total number of dwellings will remain consistent across the development with the originally approved consent (RC 2300042, stamped 15/9/2020). Should 2-3 flats be developed instead, this would result in one additional dwelling beyond the originally approved plan. This represents a minor increase in the overall number of dwellings in the development and would positively contribute to the local housing stock. These flats are envisioned as housing options tailored for retirees, offering one- or two-bedroom configurations.

As no definitive strategy has been finalised for 4 Timatanga Place, this proposal seeks approval for the building area and medium-density development aspect as part of the current consent. This approach will streamline potential future variations, saving time and resources should this direction be pursued. When the time comes to develop 4 Timatanga Place, all required processes, including obtaining building consent and complying with relevant regulations, will be diligently followed.

The surrounding site is all grass pasture with a range of small to large trees forming parts of the boundary of the site. Approximately 1.8m high existing timber fences to the North and East boundaries is to remain.

The wider vicinity is made up of residential lots, with a grass reserve/park close by and an Early Child Centre across the road.



## 3. Reasons for Application

#### 3.1 Subdivision

Resource Consent is an instant requirement for any development proposing subdivision in the Far North District.

The resource consent application is required through no less than one non-complying component of the Urban Environment, Residential Activity rules; being that each residential unit for a single household shall have available to it a minimum net site of 600m2 for sewered sites. Resource consent is further required to cover no more than four subsequent non-complying components to the Urban Environment, Subdivision Rules; being an accessway change, increase in the certificate of titles, minimum lot sizes and also allotment dimensions.

#### 3.2 Urban Environment - Residential Activity Rules

#### 7.5.6.1.2 Residential Activity a) Residential Intensity:

Each residential unit for a single household shall have available to it a minimum net site area of 600m2 for sewered sites. Any activity that does not comply with a condition for a permitted activity is a restricted discretionary activity.

This subdivision proposes one new Lot with an area of 266.75m2.

#### 3.3 Urban Environment - Subdivision Rules

#### 13.7.1 Controlled Subdivision Activities

a) There is no change in the number and location of any access to the lots involved

b) there is no increase in the number of certificates of title

The proposed subdivision will amend 6 Bisset Road title as well as adding one further title.

c) the area of each adjusted lot complies with the allowable minimum lot sizes specified for the relevant zone

As stated in section 3.1, the subdivision will add one Lot which will be smaller than what is specified as a controlled activity in the relevant zone.

#### 3.4 Urban Environment - Subdivision Rules

13.7.2.2 Allotment dimensions

Residential =  $14m \times 14m$ 

As the proposed Lot is not perfectly square; the below dimensions are nominal and reflect the



overall shape (length and width) in a general sense only.

Lot 5 nominal dimensions 15.6m x 16m

The Lots contains a greater overall area than 14x14m.

#### 3.5 All permitted and complying activities

Refer to attachment *AEE Assessment District Plan Table* for all controlled and permitted activities the subdivision proposes.



## 4. Assessment of Environmental Effects

As per Schedule 4 - Information required in application for a resource consent, subsection 6 - information required in assessment of environmental effects; the following statements confirm intent and compliance:

The proposed subdivision is not for commercial use, before, during or once complete. The lots will be used solely as residential dwellings. No commercial activity will take place on any of the proposed Lots.

Building consent will be applied for separately to this application; however, there are no hazardous installations outside of NZS 3604. The proposed subdivision comprises of an additional single story residential home (with possible future single level medium-density development). Using timber subfloor and framing, along with standard materials and processes as outlined in NZS 3604. The new homes will comply with the New Zealand Building Code.

The proposed subdivision will not produce or discharge any contaminant or hazardous substance outside regulation construction materials.

There is minimal to no earth works required, all physical waste will be stored in a skip bin and subsequently removed from the site, as per council protocol once construction comes to an end. There are no notable byproducts proposed in this consent.

As per Schedule 4 - Information required in application for a resource consent, subsection 7 - matters that must be addressed by assessment of environmental effects; the following statements confirm intent and compliance:

There are no notable trees or plants on the current section.

There are no known animal or wildlife protections or habitats on the current section.

There is no physical alteration proposed to the landscape; regarding earth works and contour.

There will be no discharge of contaminants into the environment.

The current section is not being used for recreational or community purposes.

There is no known tie of this land to any cultural or significant spiritual or community event.

There are no natural resources or natural resource access ways associated with this site.

The proposed development will not create or encourage any form of noise pollution unrelated to residential activity.



#### Environmental effects and proposed points of management or mitigation:

The proposed subdivision will have less than minor effect on those in the neighbourhood and the wider community.

As any construction is expected, there will be construction noise, increased traffic and construction hazards on the site during the subdivision and building process. These issues are unavoidable and will be managed / mitigated by the building and relocatable team. All construction works will be in accordance with relevant building / construction code standards and will be undertaken by licensed professionals.

#### Effect summary – Less than minor

The proposed subdivision will have a less than minor effect on the visual appearance on the current section and property.

The proposal looks to add a 4<sup>th</sup> dwelling to an existing 3 dwelling development. The typology will be very similar and will have a very minor impact on the overall feel and aesthetic of the street scape.

#### Effect summary – Less than minor

The subdivision will have no effect on the trees and plants on the current section.

The proposed relocated building (or potential future medium density development) will have no impact on vegetation currently within the sections. Refer Landscape Plan.

#### Effect summary – No effect

Vehicle crossing location onto Bisset Road

The existing vehicle crossing will remain as is. Refer Landscape Plan.

#### Effect summary – Less than minor

#### Shape of Lots (minimum dimension of 14m x 14m)

The shapes of Lot 5 has been derived from a number of considerations:

- Central accessway and vehicle circulation
- Existing service line
- Shapes and floor layouts of relocatable houses
- Location of existing home
- Orientation of yards and outdoor areas



#### • Vehicle maneuverability

Many planning exercises were conducted before arriving at the finalised layout which was given approval (RC 2300042, stamped 15/9/2020).

#### Effect summary – Less than minor

#### Size of the Lots

The current zoning parameters for lot sizes indicate no smaller than 600m2.

The approval of the initial six-lot scheme was influenced by its positive contribution to the community through the addition of housing stock and the presence of a large open park located directly across the road. The adjacent grass park reduces the necessity for each lot to include expansive grassed areas, thereby lowering maintenance requirements for owners and tenants while still providing access to public open space amenities. The lot sizes remain unchanged from the previously approved resource consent.

Approved RC 2300042, stamped 15/9/2020.

#### Effect summary - Less than minor

#### Increased drain on infrastructure

This does not propose the requirement of increasing infrastructure beyond the Initially approved RC.

Approved RC 2300042, stamped 15/9/2020.

#### Effect summary – Less than minor

**Activity Status:** 

Overall, consent is required as a restricted discretionary activity.



## 5. Assessment of Part 2 of RMA (relevant sections addressed)

#### **Purposes**

(1) The purpose of this Act is to promote the sustainable management of natural and physical resources.

(2) In this Act, **sustainable management** means managing the use, development, and protection of natural and physical resources in a way, or at a rate, which enables people and communities to provide for their social, economic, and cultural well-being and for their health and safety while—

(a) sustaining the potential of natural and physical resources (excluding minerals) to meet the reasonably foreseeable needs of future generations; and

- (b) safeguarding the life-supporting capacity of air, water, soil, and ecosystems; and
- (c) avoiding, remedying, or mitigating any adverse effects of activities on the environment.

The proposed subdivision does not impede or promote sustainable management of natural physical resources. It is proposed to connect to town supply for utilities; this will support sustainable systems if they are employed by the Far North District council in its supply. Or alternatively not, if they are not managed sustainably.

The section does not have any notable physical or natural features which place any significant value to the owners or community. Therefore, the proposal does not have any effect.

The proposal suggests a stormwater management plan that promotes an ecofriendly treatment of storm water, which will improve on the current site as there is nothing in place to date.

The proposal suggests a combination of relocatable homes and new build. This is a model of recycle over waste and will have a far greater positive impact on the environment than only new builds, not to mention adding historical significance to the section with homes of a different era and story.

The proposal suggests there will be no contaminants or waste products from the development, as to have no effect on the environment. The minimal build-up of waste products or building materials will be taken away from site and disposed of responsibly.

The proposal suggests there will be no commercial activity undertaken on the site currently, during or following the development, avoiding any adverse effects.

Overall, the proposal suggests a subdivision that has little to no effect on the natural environment. Little to no effect on the physical / visual perception of the property. Little to no effect on public safety through an increase of hazard or traffic consideration.

The proposal does suggest a positive impact on the housing stock for Kaikohe and follows proactive community and environmentally friendly systems to achieve it. The proposal suggests a consideration of the Far North District Plan with a goal to support the districts needs and requirements.



## 6. Notes from FNDC District Plan

The Far North District Council could be considered to be affected by this proposal due to the development falling within the restricted discretionary activity category due to the reasons mentioned in this report. No other parties have been considered affected by this proposal.

Overall, we believe this application satisfies the relevant provisions of S95 of the Resource Management Act and can lawfully be assessed without notification.

## 7. Conclusion

We believe the proposal is in line with the Far North District Plan, Residential Zone with the overall effects and as a result, the works are considered to be *less than minor*.





PROPERTIES LTD

		Urban Environment - Residential Activity Rules	<u>Compliance</u>
7.6.5.1.1		Relocated Buildings	Complies
7.5.6.1.2	a)	Residential Activity Residential Intensity Each residential unit for a single household shall have available to it a minimum net site area of: Sewered sites: 600m <sup>2</sup> Unsewered sites: 3,000m <sup>2</sup>	Does not comply
	b)	Accessory buildings on a site within the Coopers Beachfront Estate are a permitted activity provided that: (i) there is no more than one accessory building detached from each residential unit on the site; and (ii) any accessory building which is detached from the residential unit has a total floor area of no more than 45m2	Notapplicable
7.6.5.1.3		Scale of Activities The total number of people engaged at any one period of time in activities on a site, including employees and persons making use of any facilities, but excluding people who normally reside on the site or are members of the household shall not exceed: 2 persons per 600m <sup>2</sup> (sewered) 2 persons per 3,000m <sup>2</sup> (unsewered)	Notapplicable
7.6.5.1.4		<b>Building Height</b> The maximum height of any building shall be 8m.	Complies

7.6.5.1.5	<b>Sunlight</b> No part of any building shall project beyond a 45 degree recession plane as measured inwards from any point 2m vertically above ground level on any site boundary	Complies
7.6.5.1.6	<b>Stormwater Management</b> The maximum proportion of the gross site area covered by buildings and other impermeable surfaces shall be 50%	Complies
7.6.5.1.7	<b>Set Back from Boundaries</b> The minimum building setback from road boundaries shall be 3m	Complies
7.6.5.1.8	Screening for Neighbours - Non residential activities	Not Applicable
7.6.5.1.9	Outdoor activities Except as otherwise provided by Rule 7.6.5.1.10, any activity may be carried out outside except that any commercial non-residential activity involving manufacturing, altering, repairing, dismantling or processing of any materials, live produce, goods or articles shall be carried out within a building.	Complies
7.6.5.1.10	Visual Amenity	Not Applicable
7.6.5.1.11	Transportation	Not Applicable
7.6.5.1.12	Site Intensity - Non Residential Activities	Not Applicable
7.6.5.1.14	Hours of Operation	Not Applicable
7.6.5.1.14	Keeping of Animals	Not Applicable
7.6.5.1.15	Noise	Not Applicable

7.6.5.1.16		Helicopter Landing Area	Not Applicable
7.6.5.1.17		<b>Building Coverage</b> Any new building or alteration/addition to an existing building is a permitted activity if the total Building Coverage of a site does not exceed 45% of the gross site area.	Complies
		Urban Environment - Subdivision Rules	
13.7.1	a) b) c) d) e) f)	Controlled Subdivision Activities there is no change in the number and location of any access to the lots involved; and there is no increase in the number of certificates of title; and the area of each adjusted lot complies with the allowable minimum lot sizes specified for the relevant zone the area affected by the boundary adjustment is within or contiguous with the area of the original lots; and all boundary adjusted sites must be capable of complying with all relevant land use rules (e.g building setbacks, effluent disposal); and all existing on-site drainage systems (stormwater, effluent disposal, potable water) must be wholly contained within the boundary adjusted sites.	Complies Does not comply Does not comply Does not comply Complies Complies
13.7.2.1	(v)	The minimum lot sizes are 2,000 $m^2$ (unsewered) and 300 $m^2$ (sewered).	Complies
13.7.2.2		Allotment diemnsions Residential = 14m x 14m	Does not comply
13.7.2.3		Amalgamation of land in a Rural Zone	Not Applicable
13.7.2.4		Lots divided by zone boundaries	Not Applicable
13.7.2.5		Sites divided by Outstanding Landscape	Not Applicable
13.7.2.6		Acces, Utilities, Roads	Not Applicable
13.7.2.7		Savings as to Previous Approvals	Not Applicable

13.7.2.8	Proximity to top energy transmission lines	Not Applicable
13.7.2.9	Proximity to national grid	Not Applicable
13.7.3.1	<b>Property Access</b> A controlled (subdivision) activity application must comply with rules for property access in Chapter 15, namely Rules 15.1.6C.1.1 - 15.1.6C.1.11 (inclusive).	Complies
13.7.3.2	<b>Natural and other Hazards</b> Any proposed subdivision shall avoid, remedy or mitigate any adverse effects of natural hazards.	Complies
13.7.3.3	Water Supply	Complies
13.7.3.4	Stormwater Disposal	Complies
13.7.3.5	Sanitary Sewer Disposal	Complies
13.7.3.6	Energy Supply	Complies
13.7.3.7	Telecommunications	Complies
13.7.3.8	Easements for any purpose	Not applicable
13.7.3.9	Preservation of Heritage Resources	Not applicable
13.7.3.10	Access to Reserves and Waterways	Not applicable
13.7.3.11	Land use compatibility	

Subdivision shall avoid, remedy or mitigate any adverse effects of incompatible land uses (reverse sensitivity). In considering a controlled subdivision activity under Rule 13.7.3.11 the Council will restrict the exercise of its control to the following matters: (i) the degree to which the proposed allotments take into account adverse effects arising from incompatible land use activities (including but not limited to noise, vibration, smell, smoke, dust and spray) resulting from an existing land use adjacent to the proposed subdivision

13.7.3.12 Proximity to Airports

Not applicable

Complies



## RECORD OF TITLE UNDER LAND TRANSFER ACT 2017 FREEHOLD





R.W. Muir Registrar-General of Land

Identifier1101253Land Registration DistrictNorth AucklandDate Issued11 April 2023

**Prior References** NA97C/58

Estate	Fee Simple	
Area	1092 square metres more or less	
Legal Description	Lot 1 Deposited Plan 584828	
Registered Owners		
Esnem Properties Limited		

#### Interests

Subject to Part IV A Conservation Act 1987

Subject to Section 11 Crown Minerals Act 1991

12131842.2 Mortgage to ASB Bank Limited - 3.6.2021 at 4:34 pm

Subject to a right of way, right to convey electricity, telecommunications over part marked A, B and C, right to convey water over part marked A, H and a right to drain sewage over part marked B, C and K all on DP 584828 created by Easement Instrument 12709349.2 - 11.4.2023 at 2:27 pm


Appurtenant hereto is a right to drain water created by Easement Instrument 12709349.2 - 11.4.2023 at 2:27 pm

The easements created by Easement Instrument 12709349.2 are subject to Section 243 (a) Resource Management Act 1991

Subject to a right (in gross) to drain sewage over part marked A on DP 584828 in favour of Far North District Council created by Easement Instrument 12709349.3 - 11.4.2023 at 2:27 pm

The easements created by Easement Instrument 12709349.3 are subject to Section 243 (a) Resource Management Act 1991



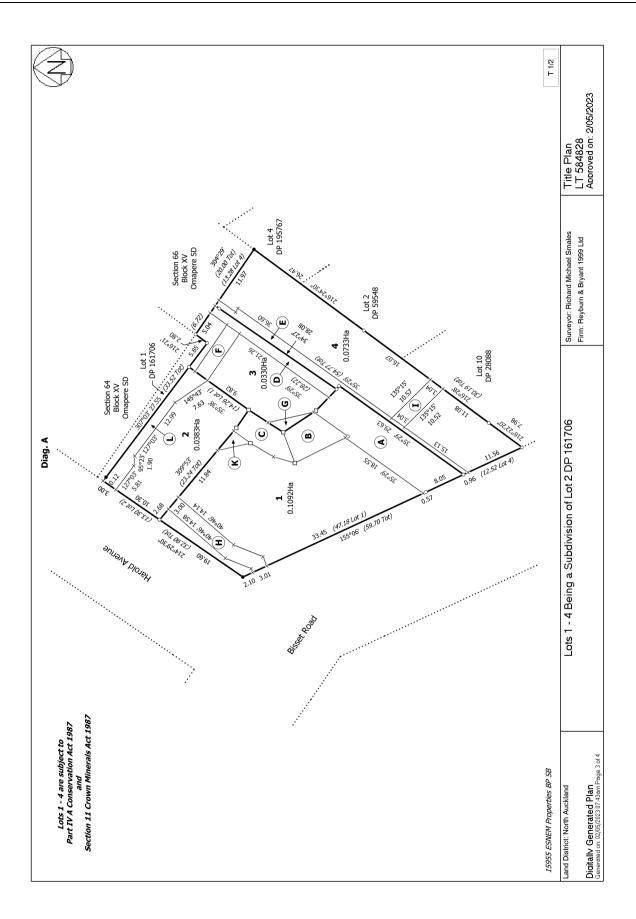



## RECORD OF TITLE UNDER LAND TRANSFER ACT 2017 FREEHOLD

**Search Copy** 



R.W. Muir Registrar-General of Land

Identifier1101256Land Registration DistrictNorth AucklandDate Issued11 April 2023

Prior References NA97C/58

Estate	Fee Simple	
Area	733 square metres more or less	
Legal Description	Lot 4 Deposited Plan 584828	
Registered Owners		
Esnem Properties Limited		

#### Interests

Subject to Part IV A Conservation Act 1987

Subject to Section 11 Crown Minerals Act 1991

12131842.2 Mortgage to ASB Bank Limited - 3.6.2021 at 4:34 pm

Subject to a right to convey water over part marked E and a right to drain water over parts marked E and I all on DP 584828 created by Easement Instrument 12709349.2 - 11.4.2023 at 2:27 pm


Appurtenant hereto is a right of way, right to convey electricity, telecommunications and water created by Easement Instrument 12709349.2 - 11.4.2023 at 2:27 pm

The easements created by Easement Instrument 12709349.2 are subject to Section 243 (a) Resource Management Act 1991

Subject to a right (in gross) to drain sewage over part marked E on DP 584828 in favour of Far North District Council created by Easement Instrument 12709349.3 - 11.4.2023 at 2:27 pm

The easements created by Easement Instrument 12709349.3 are subject to Section 243 (a) Resource Management Act 1991



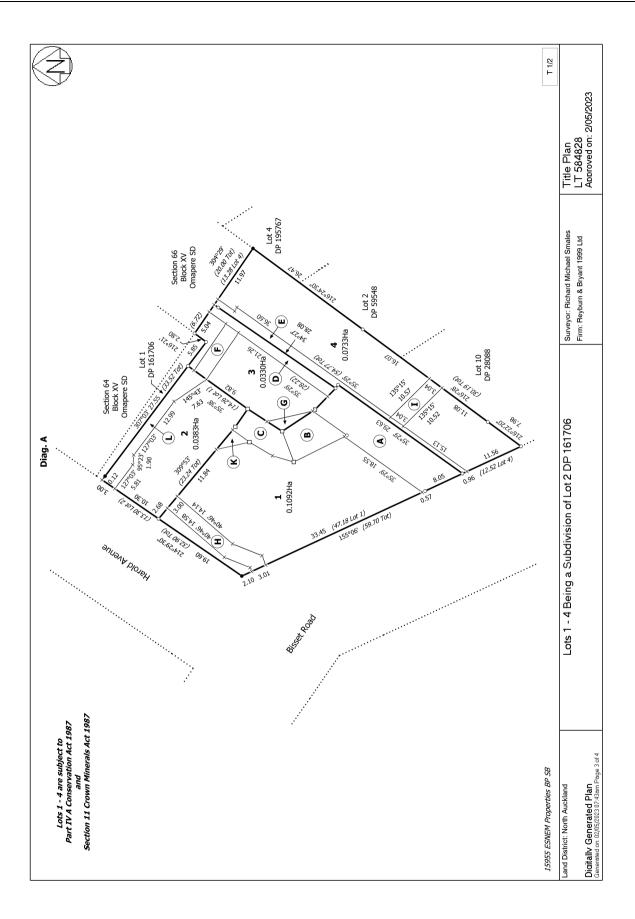



#### Scale: 1:1000

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If any survey marks (inverted purple triangles) appear on this image and are at risk from your works please fill in the response form. If no marks are shown or affected, no further action is required.

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## **Response Cover Letter**



Land Information New Zealand (LINZ) PO Box 5501 Wellington 6145

www.linz.govt.nz

Date: 16/09/2020

To: Mr Shane Tregidga Not Supplied 6 Tahora Avenu Remuera Not Supplied 1050

Your request has been successfully processed. Please review the attached Plan for survey markers in and around your enquiry location, and complete the attached Form within two clear business days of this response, if your work will impact these marks:

Sequence No:	8745322
Job No:	1709066
Location:	6 Bisset Road Kaikohe Northland 0405

If you require further information, please contact LINZ on 0800 665 463 or beforeudig@linz.govt.nz

*Important Notice:* This enquiry response, including any associated documentation, has been assessed and compiled from the information detailed within the beforeUdig enquiry outlined above. Please ensure that the beforeUdig enquiry details and this response accurately reflect your proposed works.

This response is intended for use only by the addressee. If you have received the enquiry response in error, please let us know by telephone and delete all copies; you are advised that copying, distributing, disclosing or otherwise acting in reliance on the response is expressly prohibited.



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Caller Id: 174358

Not Supplied

Mobile:

Email:

Not Supplied

**Phone:** 0212506671

Fax:

esnempropertiesItd@gmail.com

Job No 1709066


#### Caller Details

;

Mr Shane Tregidga Not Supplied 6 Tahora Avenu Remuera Auckland 1050

#### **Dig Site and Enquiry Details**

**WARNING:** The map below only displays the location of the proposed dig site and does not display any asset owners' pipe or cables. The area highlighted has been used only to identify the participating asset owners, who will send information to you directly.

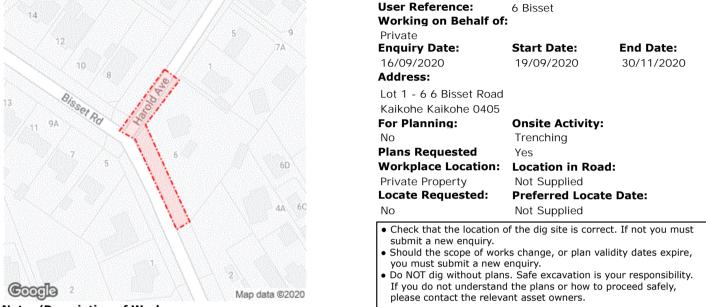

#### Notes/Description of Works:

New double width concrete vehicle entrance as per engineer design (Bisset Road - min. 30m from intersection). Extend the water supply rider main from Harold Ave to serve development.

#### Your Responsibilities and Duty of Care

- If plans are **not** received within **<u>2</u> working days**, contact the asset owners directly & quote their Sequence No.
- ALWAYS perform an onsite inspection for the presence of assets. Should you require an onsite location, contact the asset owners directly. Please remember, plans do not detail the exact location of assets.
- Pothole to establish the exact location of all underground assets using a hand shovel, before using heavy machinery.
- Ensure you adhere to any legislative requirements regarding Duty of Care and safe digging requirements.
- If you damage an underground asset you MUST advise the asset owner immediately.
- By using the beforeUdig service, you agree to our privacy policy and the terms and conditions set out at www.beforeudig.co.nz
- For more information about the beforeUdig service, visit www.beforeudig.co.nz

#### **Asset Owner Details**

The assets owners listed below have been requested to contact you with information about their asset locations within 2 working days.

Additional time should be allowed for information issued by post. It is **your responsibility** to identify the presence of any underground assets in and around your proposed dig site. Please be aware, that not all asset owners are registered with the beforeUdig service, this confirmation will not provide details of those asset owners so it is **your responsibility** to identify and contact directly any asset owners not listed here. Known Non-Member Utilities are listed on the beforeUdig website under the 'Utilities & Members' Tab.

Any asset owner name listed below with the status 'Not Notified' is an associate member of beforeUdig which only notifies you of their presence and you will need to contact them directly.

Where an Asset Locate has been requested, Utilities will endeavour to respond to your Preferred Locate Date, where possible. Asset owners highlighted by asterisks **\*\* Do Not** supply plans and/or information regarding the existence of underground assets on private property. # Asset owners highlighted with a hash request you reference their attachment for further instructions on how to obtain plans.

Seq. No.	Authority Name	Phone	Status
8745321	Chorus **	0800822003	Notification Sent
8745319	Far North District Council - CAR Only	0800920029	CAR Not Required
8745322	LINZ	044983835	Notification Sent
8745320	Top Energy	0800867363	Not Notified

END OF UTILITIES LIST

## SITE INSPECTION RECORD

ENGINEERING SOLUTIONS Whangarei 0110



	1	Consulting Engineers			
CES JOB No. & REV.	22-0230 INSPECTION No. 001				
ADDRESS	6 Bisset Road, Kaikohe				
INSPECTOR	ОМс				
TYPE OF INSPECTION	Private road				
CONSENT No.	ТВС	DATE AND TIME 09:00am 28/02/22			
H & S ISSUES ON SITE	-	H & S 'TAKE 5'			
Inspected private road	d post-pour:				
<ul> <li>Row B 3.0 wide sea</li> <li>Row C 3.0 wide sea</li> <li>4/300x300 Sump. O</li> <li>uPVC trafficable cha</li> </ul>	annel drain. OK	10 Basecourse. OK			
<ul> <li>Dished channel. OK</li> <li>Crossing meets flus</li> </ul>	h with road edge. OK				
	gineering plans complete				
	Ecnom Proportion				
SITE CONTACT PASS  SIGNE	Esnem Properties	COUNCIL INSPECTOR -			
PASS  SIGNE PENDING	D Quart				
FAIL O SIGNE	D				
	jobs@coreeng.nz         Level 1, 31 Vine Street         Structural   Geotechnical   Civil   Environmental				

Structural | Geotechnical | Civil | Environmental

## **SCHEDULE** 1C



CERTIFICATION UPON COMPLETION OF LAND DEVELOPMENT/SUBDIVISION
ISSUED BY: Core Engineering Solutions
(Approved certifier firm)
TO: ESNEM Properties
<i>(Developer/owner)</i> TO BE SUPPLIED TO: Far North District Council
(Territorial authority)
FOR: Private Rd
(Description of land development/subdivision)
AT: 6 Bisset Road, Kaikohe, Northland
(Address)
Core Engineering Solutions has been engaged by
(Consultant/designer) (Developer/owner)
to provide construction observation review and certification services for the above subdivision
which is described in the specification and shown on the drawings numbered ED01-ED15
approved by
<i>(Territorial authority)</i> I have sighted the Far North District Council consent and conditions of subdivision
(Territorial authority)
and the approved specification and drawings.
On the basis of periodic reviews of the construction and information supplied by the contractor in the course of the construction, I believe on reasonable grounds that the infrastructure other than those outstanding works listed below, is complete and has been constructed in accordance with:
<ul> <li>(a) The approved engineering drawings and specifications and any approved amendments;</li> <li>(b) The Council's Engineering Standards; and</li> </ul>
(c) The manufacturer's instructions
Date 2/03/2015
(Signature of approved certifier on behalf of the approved certifier firm)
(Name, title, and professional qualifications)
NOTE – This statement shall only be relied upon by the territorial authority named above. Liability under this statement accrues to the approved certifier firm only. The total maximum amount of damages bayable arising from this statement and all other statements provided to the territorial authority in relation to this land development/ subdivision, whether in contract, tort, or otherwise (including
negligence), is limited to the sum of \$. 2000000 (insert).
Outstanding works
Copyright waived

40

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**SCHEDULE 1A DESIGN CERTIFICATE – LAND DEVELOPMENT/SUBDIVISION** Cove Ensmeering ISSUED BY:. (Approved certifier firm/suitably qualified design professional) (CE operties. (Developer/owner) ar Novt TO BE SUPPLIED TO: (Territorial authority) 0 Description of land development/subdivision) Lot (Address) has been engaged by ESNEM Roperties 'ES Ho (Developer/owner) (Consultant/designer) to provide... Er S. services for the land development and/or subdivision described above. Ref : 27 R 30........have the gualifications and experience relevant to this project as set out herein and have designed the land development/subdivision and confirm that the design is to current engineering practice, and that I believe on reasonable grounds that it satisfies all relevant resource consent conditions, all codes and standards. I/My practice holds professional indemnity insurance to the amount of \$5000000.and includes run-off cover. 15/12/202  $\supset$ Date (Signature of approved certifier on behalf of the approved certifier firm) drew Leslie (Name, title, and professional qualifications) NOTE - This statement shall only be relied upon by the territorial authority named above. Liability under this statement accrues to the approved certifier firm only. The total maximum amount of damages payable arising from this statement and all other statements provided to the territorial authority on this land development/subdivision, whether in contract, tort, or otherwise (including negligence), is limited to the sum of \$. Ret. (insert) MSUCACE al Copyright waived

NZS 4404:2010

# 6 Bisset Road, Kaikohe

for Resource Consent




Asbuilt sheet Index								
Layout ID	Issue ID	Issued Date						
1AB01	As-Built Cover Sheet	01	21/09/22,					
1AB02	Asbuilt Plan - Service Layout 01	01	21/09/22,					
1AB03	Asbuilt Plan - Service Layout 02	01	21/09/22,					

	T: 09 553 3660 jobs@coreeng.nz Level 1, 31 Vine Street,			CLIENT: Esnem Properties Ltd	PROJECT DESCRIPTION: 6 Bisset Road Development	APPROVED BY: SCALE:
ENGINEERING SOLUTIONS	Whangarei 0110	10/9/21		6 Bisset Road, Kaikohe,	SHEET TITLE: As-Built Cover Sheet	SHEET:
Structural   Geotechnical   Civil	Re	ev Date	Notes	Northland		1AB01

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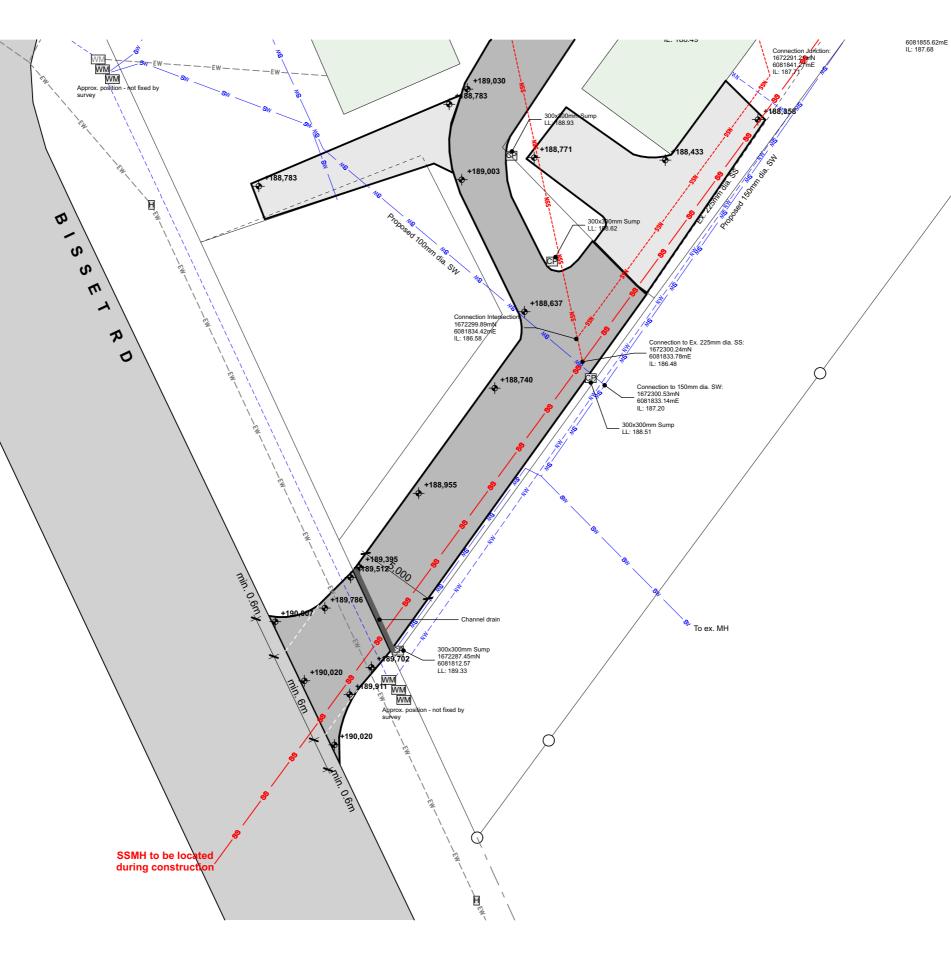
Legend:	$\bigcirc$
10,000L detention tanks	(т)
225mm Existing SS line	
100mm Proposed SS line	NSS
150mm Proposed SW line	
Existing water supply	— — — — EW — — –
New water supply	NSW
Water supply rider main extension	
Proposed SW Cesspit	CP
Existing water meter	WM
Proposed water meter	WM
Existing hydrant	Ħ
Ex. water supply valve	$\boxtimes$

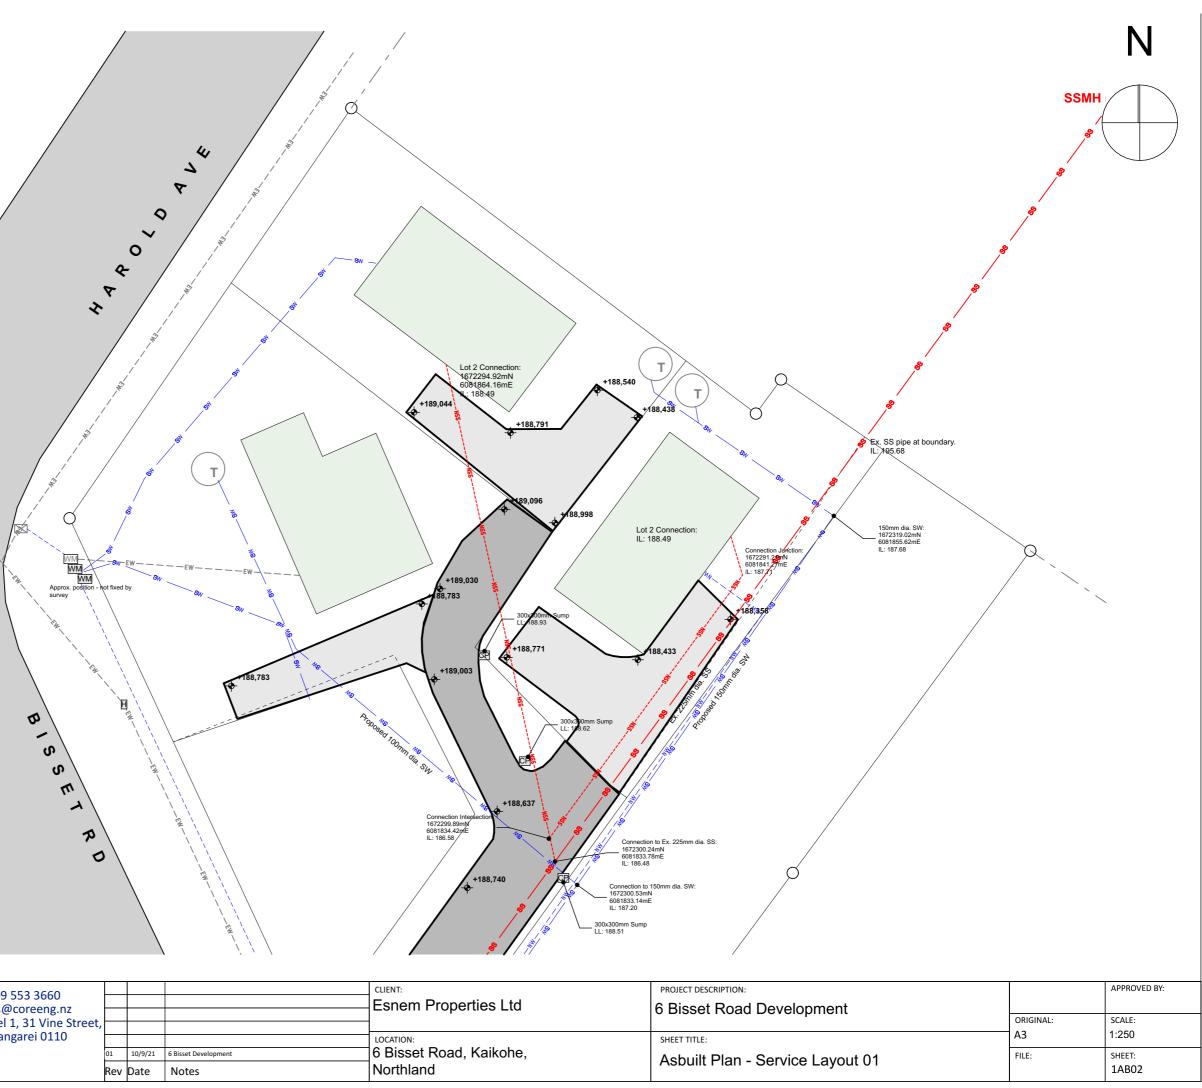

CORE Consulting Engineers	T: 09 553 3660 jobs@coreeng.nz Level 1, 31 Vine Street,				CLIENT: Esnem Properties Ltd	PROJECT DESCRIPTION: 6 Bisset Road Developmen
ENGINEERING SOLUTIONS	Whangarei 0110	01	10/9/21	6 Bisset Development	LOCATION: 6 Bisset Road, Kaikohe,	SHEET TITLE: Asbuilt Plan - Service Layo
Structural   Geotechnical   Civil	F	Rev	Date	Notes	Northland	

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Legend:	$\bigcirc$
10,000L detention tanks	(т)
225mm Existing SS line	
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New water supply	NSW
Water supply rider main extension	
Proposed SW Cesspit	CP
Existing water meter	WM
Proposed water meter	WM
Existing hydrant	H
Ex. water supply valve	$\boxtimes$



Consulting jobs	9 553 3660 @coreeng.nz el 1, 31 Vine Street,			CLIENT: Esnem Properties Ltd	PROJECT DESCRIPTION: 6 Bisset Road Developme
ENGINEERING SOLUTIONS Wha	angarei 0110	10/9/21	6 Bisset Development	LOCATION: 6 Bisset Road, Kaikohe,	SHEET TITLE:
Structural   Geotechnical   Civil	Rev	v Date		Northland	Asbuilt Plan - Service La


ent		APPROVED BY:
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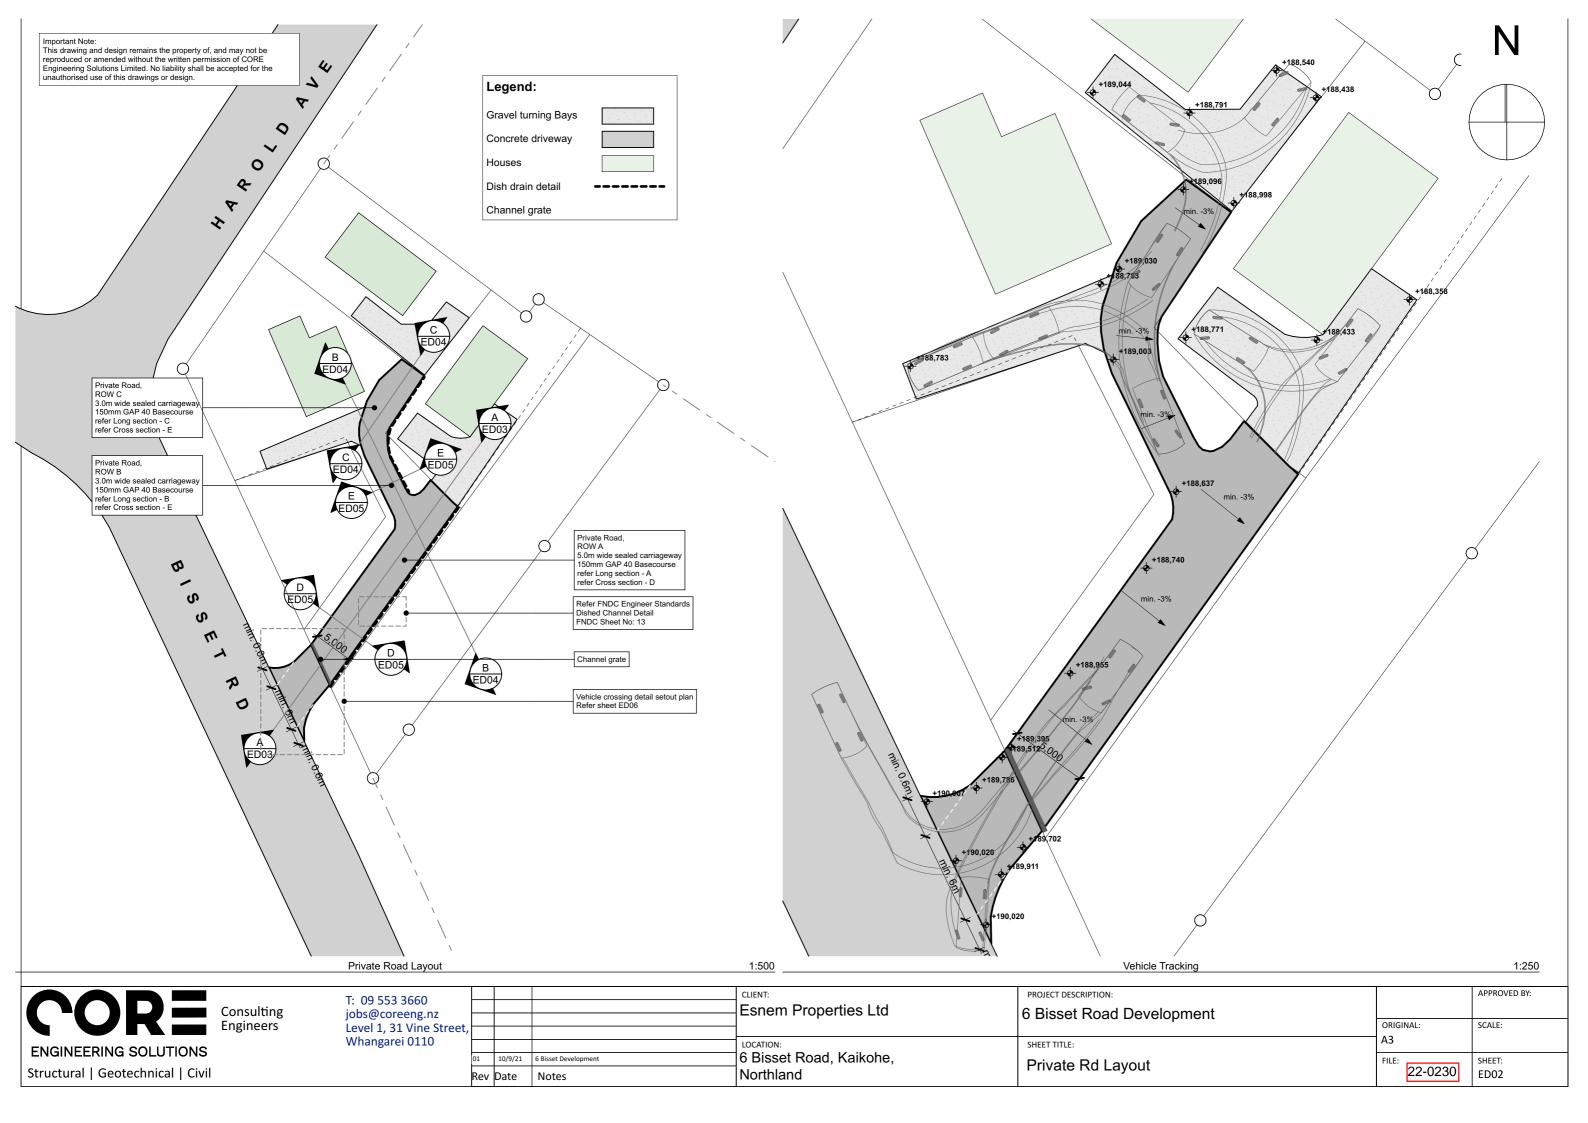
# 6 Bisset Road, Kaikohe


for Resource Consent



Sheet Index			
Layout ID	Layout Name	Issue ID	Issue Date
ED01	Cover Sheet	01	21/09/22
ED02	Private Rd Layout	01	21/09/22
ED03	Section A	01	21/09/22
ED04	Section B & C	01	21/09/22
ED05	Section D & E	01	21/09/22
ED06	Vehicle Crossing	01	21/09/22
ED07	Engineering Standards - Vehicle Crossing 01	01	21/09/22
ED08	Engineering Standards - Vehicle Crossing 02	01	21/09/22
ED09	Engineering Standards - Kerb/channel & Cesspit	01	21/09/22
ED010	Service Layout 01	01	21/09/22
ED011	Service Layout 02	01	21/09/22
ED012	SS01 & SS02 Long Sections	01	21/09/22
ED013	SW01, SW02 & SW03 Long Sections	01	21/09/22
ED014	SW03 Long Section, FNDC Pipe Bedding	01	21/09/22
ED015	Engineering Standards - Stormwater	01	21/09/22

	T: 09 553 3660 jobs@coreeng.nz		CLIENT: Esnem Properties Ltd	PROJECT DESCRIPTION: 6 Bisset Road Development		APPROVED BY:
ENGINEERING SOLUTIONS	Level 1, 31 Vine Street, Whangarei 0110		LOCATION:	SHEET TITLE:	ORIGINAL: A3	SCALE:
Structural   Geotechnical   Civil	⊡ R	 6 Bisset Development Notes	6 Bisset Road, Kaikohe, Northland	Cover Sheet		SHEET: ED01

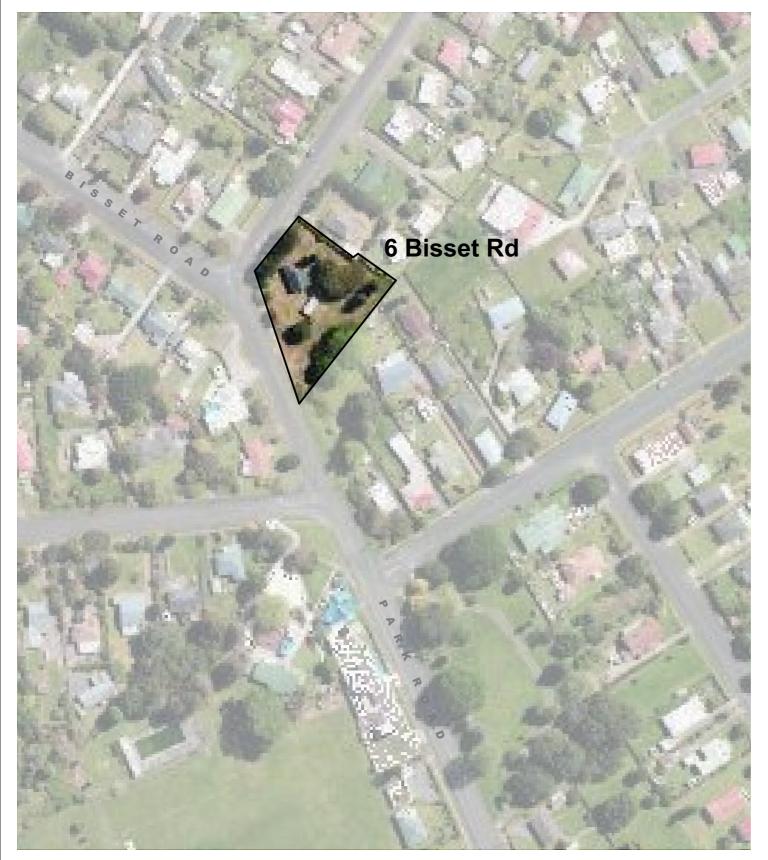

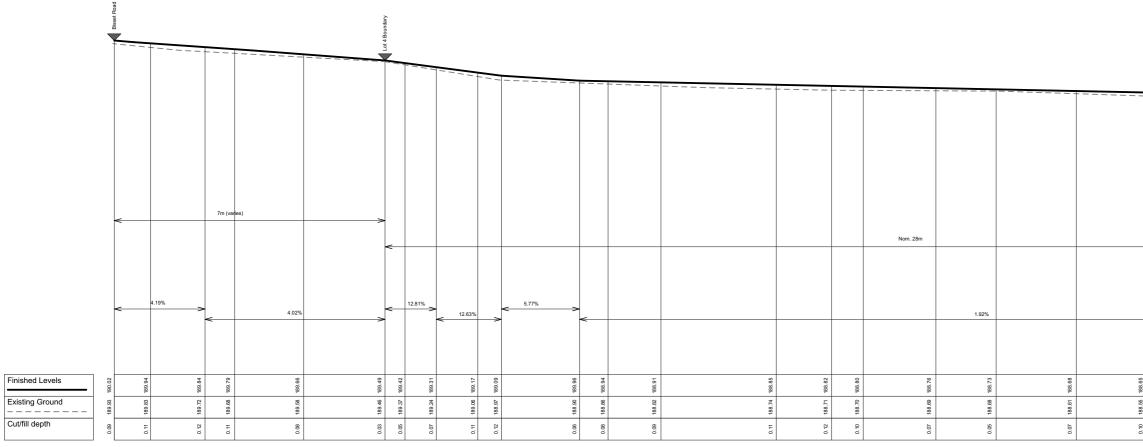

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Longitudinal Section - ROW A


Consulting j	T: 09 553 3660 obs@coreeng.nz Level 1, 31 Vine Street,				CLIENT: Esnem Properties Ltd	PROJECT DESCRIPTION: 6 Bisset Road Developme
ENGINEERING SOLUTIONS	Whangarei 0110	01	10/9/21	6 Bisset Development	LOCATION: 6 Bisset Road, Kaikohe,	SHEET TITLE:
Structural   Geotechnical   Civil	R		Date		Northland	Section A


					End of private road (carriage
_					
					>
188.65	188.60	188.56	188.52	188.49	188.48
188.55	188.48	188.44	188.41	188.39	188.38
0.10	0.12	0.12	0.1	0.10	0.10

1:100

eΑ),

ent		APPROVED BY:
	ORIGINAL: A3	scale: 1:100
	FILE: 22-0230	SHEET: ED03

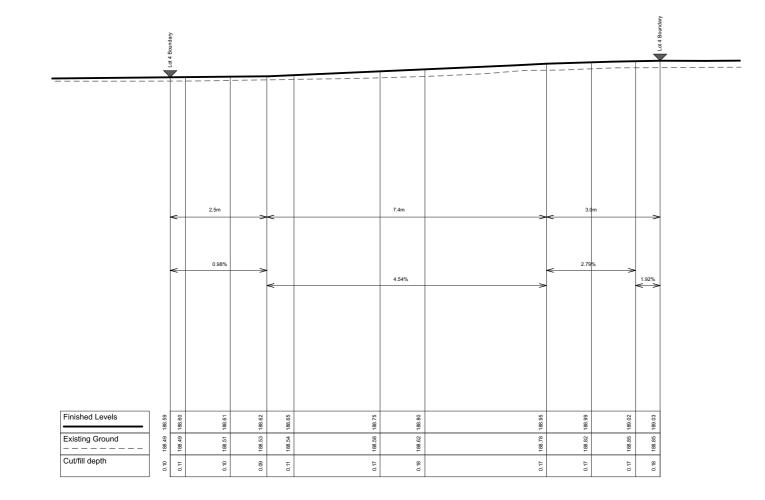

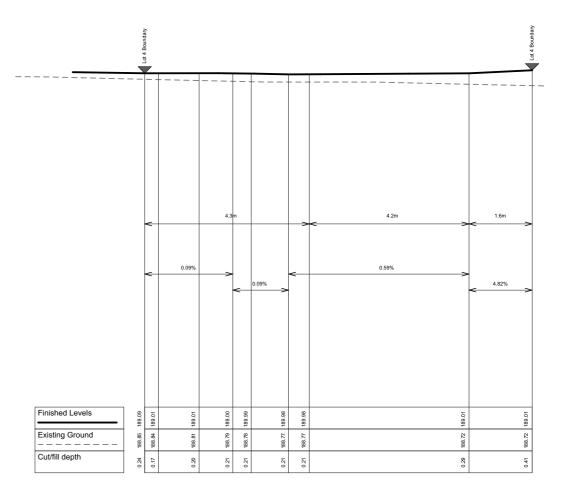

В

Longitudinal Section - ROW B

1:100

С

Longitudinal Section - ROW C


	T: 09 553 3660			CLIENT:	PROJECT DESCRIPTION:		APPROVED BY:
Consulting	jobs@coreeng.nz			Esnem Properties Ltd	6 Bisset Road Development		
Engineers	Level 1, 31 Vine Street,					ORIGINAL:	SCALE:
	Whangarei 0110			LOCATION:	SHEET TITLE:	A3	1:100
ENGINEERING SOLUTIONS		01 10/9/21	6 Bisset Development	6 Bisset Road, Kaikohe,	Section B & C	FILE:	SHEET:
Structural   Geotechnical   Civil		Rev Date	Notes	Northland		22-0230	SHEET: ED04


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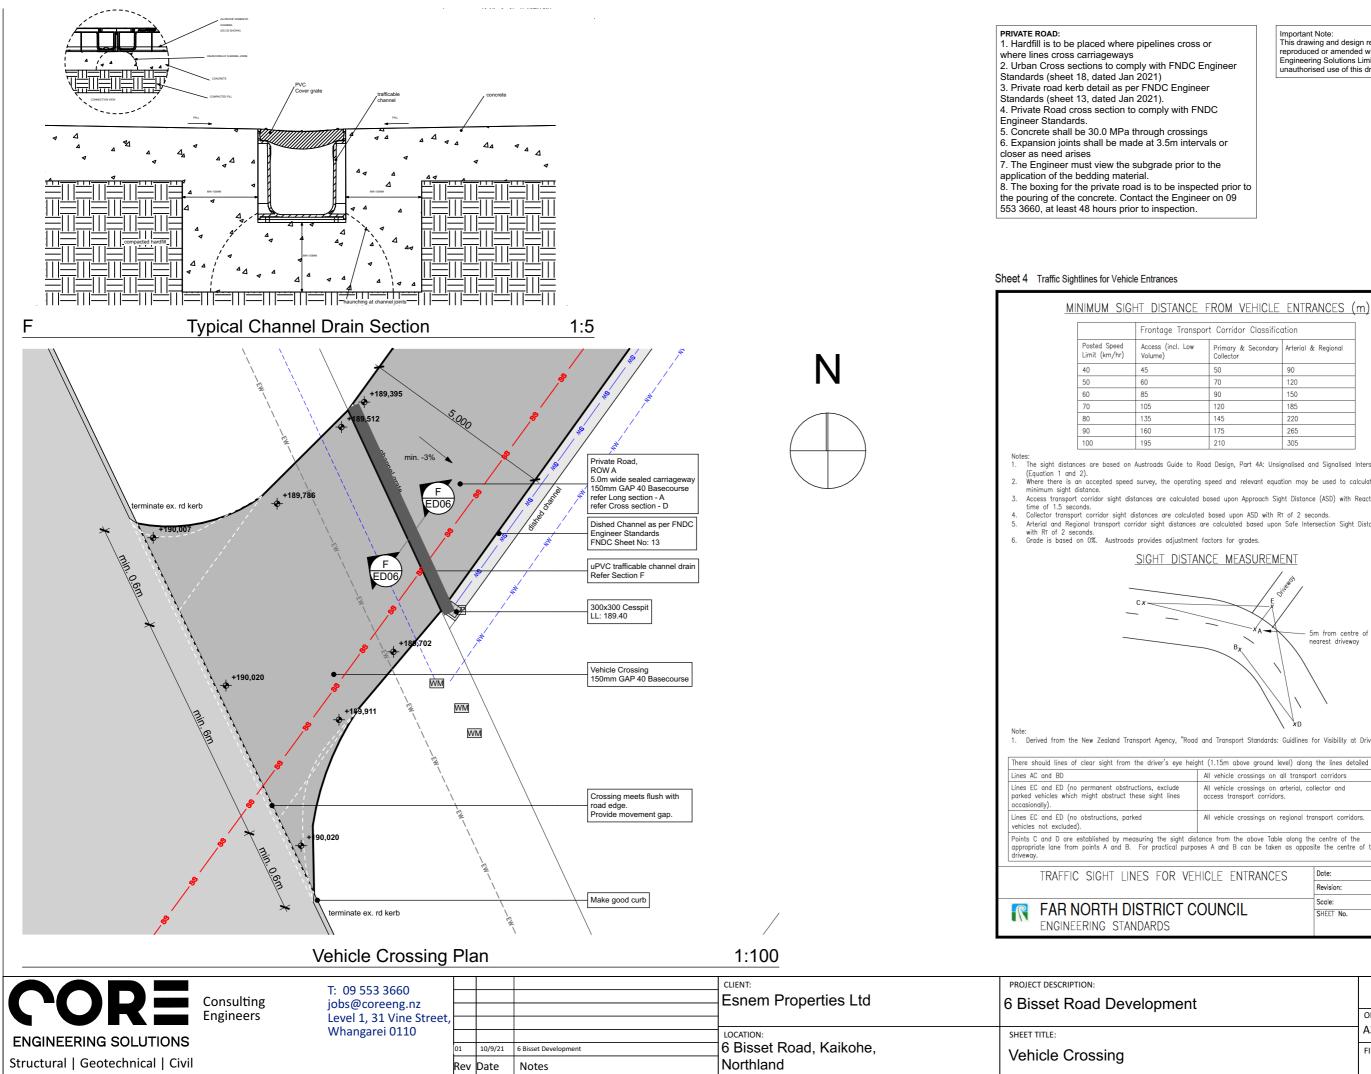
PRIVATE ROAD:

- 1. Hardfill is to be placed where pipelines cross or where lines cross carriageways 2. Urban Cross sections to comply with FNDC Engineer Standards (sheet 18, dated Jan 2021) 3. Private road kerb detail as per FNDC Engineer
- Standards (sheet 13, dated Jan 2021). 4. Private Road cross section to comply with FNDC
- Private Road cross section to comply with FNDC Engineer Standards.
   Concrete shall be 30.0 MPa through crossings
   Expansion joints shall be made at 3.5m intervals or closer as need arises
   The Engineer must view the subgrade prior to the application of the bedding material.
   The boxing for the private road is to be inspected prior to the pouring of the concrete. Contact the Engineer on 09 553 3660, at least 48 hours prior to inspection.



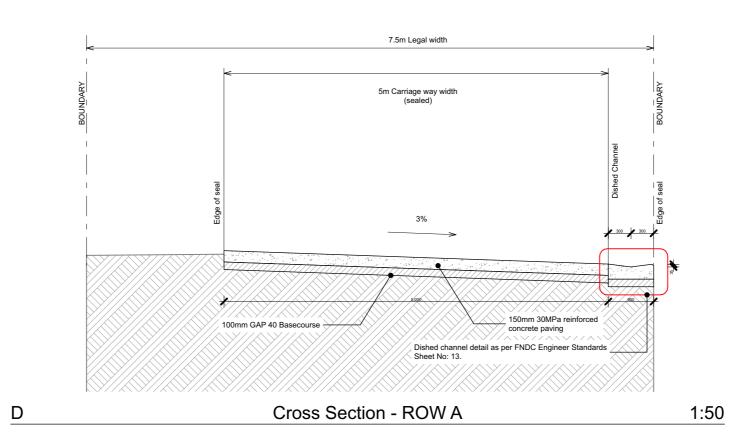

	T: 09 553 3660		CLIENT: Esnem Properties Ltd	PROJECT DESCRIPTION: 6 Bisset Road Development		APPROVED BY:
Engineers	evel 1, 31 Vine Street, Whangarei 0110		LOCATION:	SHEET TITLE:		SCALE: 1:100
Structural   Geotechnical   Civil	01 10/9/ Rev Date	Ø/21     6 Bisset Development       re     Notes	6 Bisset Road, Kaikohe, Northland	Section D & E	FILE: 22-0230	SHEET: ED05

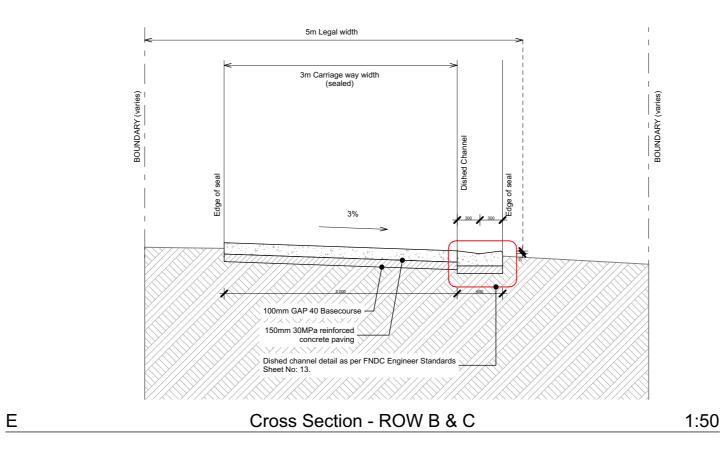


		30		
		120		
		150		
		185		
		220		
		265		
	210	305		
	Road Design, Part 4A: Unsign	-		
operatin	g speed and relevant equation	n may be used to ca	Iculate the	
alculated	d based upon Approach Sight	Distance (ASD) with F	Reaction (RT)	
calculat	ed based upon ASD with RT are calculated based upon S	of 2 seconds.		
ustment	factors for grades.			
DISTA	NCE MEASUREME	NT		
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_	E A	/		
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	×A-	5m from centre		
	B <sub>X</sub>	nearest driveway	у	
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		1, ,		
	$\backslash$	xD		
"Pog-	and Transport Standard O		Drivoways "	
, rtodd	and Transport Standards: G	liullines for visibility at	Driveways.	
eye heia	ht (1.15m above ground leve	el) along the lines deta	ailed below.	
,	All vehicle crossings on all			
ie	All vehicle crossings on art			
es	access transport corridors.			
	All vehicle crossings on ro	ional transport corrido	irs	
	All vehicle crossings on reg	jonal transport corrido	10.	
	tance from the above Table ses A and B can be taken o			
100		Detai		
VE	HICLE ENTRANCES		JAN 2021	
		Revision:	0.1	
ТС	OUNCIL	Scale:	AS SHOWN	
	CONCIL	SHEET No.	4	
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ent			A3	SCALE: 1:100 SHEET:

50

Primary & Secondary Arterial & Regional Collector

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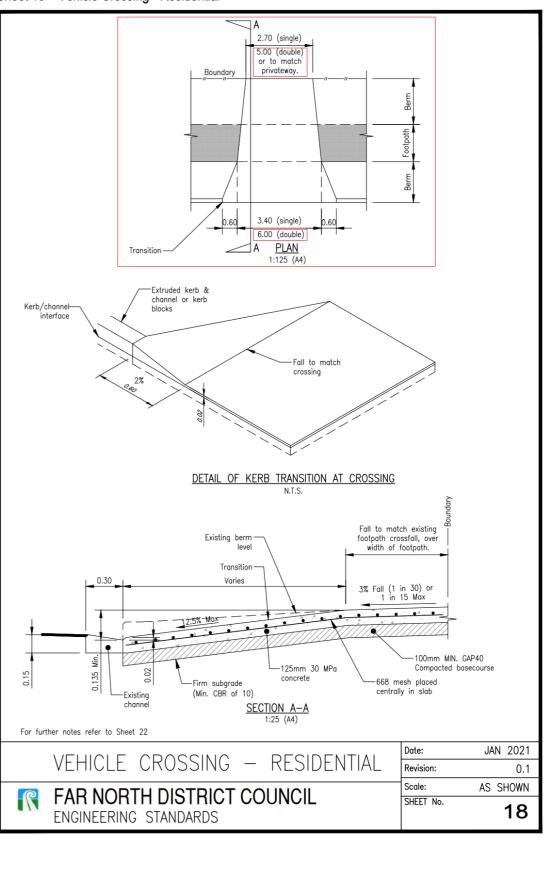
side of all vehicles. alternative channel crossing detailed on Sheet 20 may only be used with specific ap by of existing seal precludes the standard option. footpath, allowance shall be made for such with a 3% crossfall to the kerb. transitions to be constructed of similar materials to the adjacent kerb or cast insit a the footpath or adjacent property level is below the channel level, ramp the cross ce water while maintaining vehicle clearance. A freeboard of 200mm above the char is the road. ent of crossing not to exceed 12.5% (1 in 8) ings for all private accessways shall be commercial grade to Sheet 19. is of footpath and back of channel to be saw cut. assings require council inspection prior to pouring concrete. e edge of the crossing is within 1m of a crack or joint in an existing footpath ther red. nercial and industrial channels to be reinforced with an extension of the 668 mesh. a street sump is located within the proposed crossing, the sump shall be relocate nected to the council storm water system. to Sheet 16 for vehicle crossing over a drainage swale. water kerb connections generally not permitted. (See Section 4.3.17.2). width may need to be increased in some circumstances to accommodate an 11.5m OSSINGS are to be RCRRJ Class "4".
phoncrete to be 30 MPa strength at 28 days. ings to be constructed to match existing footpath and channel levels and be graded side of all vehicles. alternative channel crossing detailed on Sheet 20 may only be used with specific apply of existing seal precludes the standard option. footpath, allowance shall be made for such with a 3% crossfall to the kerb. transitions to be constructed of similar materials to the adjacent kerb or cast insitu a the footpath or adjacent property level is below the channel level, ramp the crossi- ce water while maintaining vehicle clearance. A freeboard of 200mm above the cha- the road. ent of crossing not to exceed 12.5% (1 in 8) ings for all private accessways shall be commercial grade to Sheet 19. a of footpath and back of channel to be saw cut. assings require council inspection prior to pouring concrete. : edge of the crossing is within 1m of a crack or joint in an existing footpath then the council duality water system. to Sheet 16 for vehicle crossing over a drainage swale. Invater kerb connections generally not permitted. (See Section 4.3.17.2). width may need to be increased in some circumstances to accommodate an 11.5m <u>OSSINGS</u> are to be RCRRJ Class "4". are to be adequate for the upstream catchment, but not less than 300mm dia or
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<ul> <li>the footpath or adjacent property level is below the channel level, ramp the crossic erwater while maintaining vehicle clearance. A freeboard of 200mm above the chart the road.</li> <li>ent of crossing not to exceed 12.5% (1 in 8)</li> <li>ings for all private accessways shall be commercial grade to Sheet 19.</li> <li>is of footpath and back of channel to be saw cut.</li> <li>rossings require council inspection prior to pouring concrete.</li> <li>is edge of the crossing is within 1m of a crack or joint in an existing footpath then red.</li> <li>intercial and industrial channels to be reinforced with an extension of the 668 mesh.</li> <li>is a street sump is located within the proposed crossing, the sump shall be relocate nected to the council storm water system.</li> <li>its Sheet 16 for vehicle crossing over a drainage swale.</li> <li>inwater kerb connections generally not permitted. (See Section 4.3.17.2).</li> <li>width may need to be increased in some circumstances to accommodate an 11.5m</li> <li>OSSINCS</li> <li>are to be RCRRJ Class "4".</li> </ul>
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are to be adequate for the upstream catchment, but not less than 300mm dia or
racted to the correct line and level to maintain arainage paths.
de traversable culvert safety ends. See Section 1.2.27.4
rays shall be located to allow vehicle parking clear of the road shoulder.
um sight distance requirements for entrance crossings are to comply with Sheet 4.
ossings adjoining sealed public roads are to be sealed or concrete, to the property
rete crossings shall start at least 0.5m outside of the existing edge of seal or 0.5m ed by the standard whichever is the further.
ete entrance crossings are to be 125mm of 30MPa concrete for light vehicle acces m thick of 30MPa concrete reinforced with 665 mesh unless specifically designed.
aled crossings shall comprise not less than 125mm GAP 65 and 75mm GAP40 or 20
pplication of Type 2 crossing refer to Section 1.2.27.4.
e local widening is required (Types 2 and 3) the tapers shall be sealed.
EHICLE CROSSING NOTES

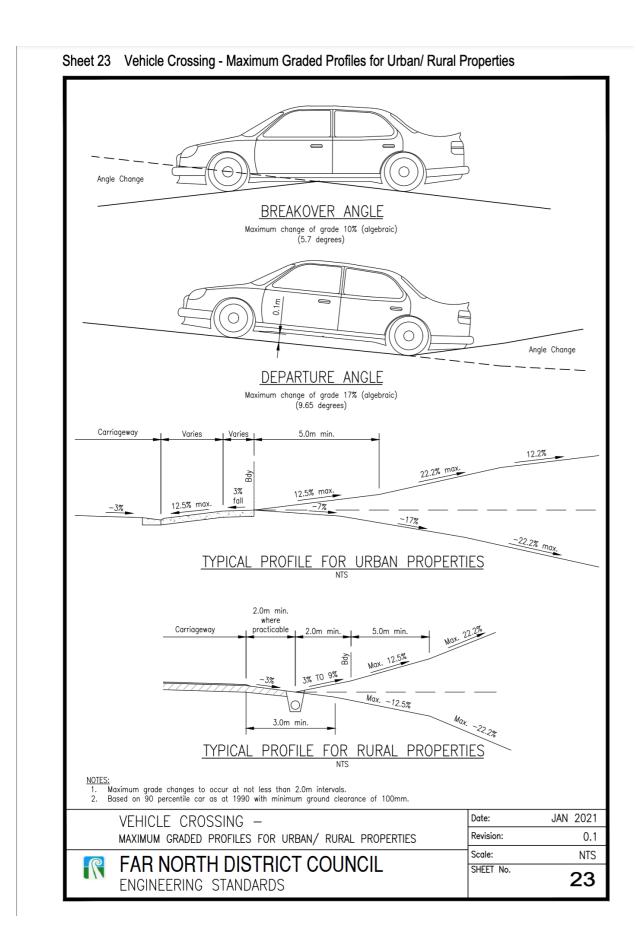		T: 09 553 3660				CLIENT:	PROJECT DESCRIPTION:
	Consulting	jobs@coreeng.nz	<u> </u>			Esnem Properties Ltd	6 Bisset Road Developme
	Engineers	Level 1, 31 Vine Street,					<u> </u>
ENGINEERING SOLUTIONS		Whangarei 0110				LOCATION:	SHEET TITLE:
			01	10/9/21	6 Bisset Development	6 Bisset Road, Kaikohe,	Engineering Standards -
Structural   Geotechnical   Civil			Rev	Date	Notes	Northland	


l be graded to give	e sufficient clearance to the		
specific approval.	It is for use only where thick		
erb.			
	te. See Sheet 12 for details.		
the crossing up f	rom the channel to control		
ve the channel is	required to contain stormwater		
stoath then that a	ection of footpath shall be		
apara anon unut St	in the second single be		
668 mesh.	and a filler and the		
pe relocated to the	e side of the crossing and		
e an 11.5m rigid t	ruck.		
mm dia or the dow	vnstream culvert and shall be		
Sheet 4.			
e property boundar	y or 10m (whichever is greater)		
eal or 0.5m outside	e of the carriageway width		
	vy vehicle crossings shall be		
designed. AP40 or 200mm G	AP 40 (compacted depths).		
10 01 2001111 0			
		2021	
USE)	Revision: Scale: AS St	0.1	
	SHEFT No		
		22	
		[	APPROVED BY:
ent			APPROVED BY:
ent		ORIGINAL:	APPROVED BY: SCALE:
	Crossing 01	ORIGINAL: A3 FILE: 22-0230	


NO	TES:	
	standards are minimum and may need to be increased to cope with services, topographical and blems, or similar.	drainage
1.	Access longitudinal gradients shall not be steeper than 1:4.5 (22.2%) unless specifically approved first 5m within the property shall not exceed 1:8 (12.5%).	. the
2.	Pavements shall be 30 MPa concrete 125mm thick with 665 mesh (or as approved) with constru- joints @ 3.5m centres on 100mm compacted basecourse.	uction
	OR, Where the subgrade CBR is not less than 7 the sub-base shall be 150mm of GAP 65 with of selected blue GAP 40 basecourse with either a chip seal, or a minimum of 30mm of asphalt concrete over a waterproofing seal coat.	
	${\sf OR},$ specifically designed by a council approved SQEP, and in particular where the subgrade CBR than 7.	is less
3.	If kerb blocks are used, concrete channels shall also be provided for gradients steeper than 1:12	2.5 (8%).
4.	The alternative channel may only be used with specific approval and must be slipformed. It sho used in business environments.	ıll not be
5.	Privateways with a carriageway less the 4.5m shall have passing bays at no more than 50m spo subject to adequate visibility, or as approved.	scing,
6.	Gated privateways shall ensure that vehicles are not required to park on the road affecting throut traffic.	Jgh
7.	Sealed surfaces may be grade 4 chip with a grade 6 dry locking coat chip rolled in within 5 ho the application of the grade 4 chip, OR, as approved.	ours of
8.	The Clegg Impact Value prior to sealing shall be not less than 40 tested at 10m intervals.	
9.	Concrete vehicle crossings shall comply with Sheet 19 or as approved including drainage provisio required.	ns as
10.	Privateways containing public watermains, sewers, or cables, must be of adequate width for sepa services to comply with Table 4.10, or as approved.	ration of
11.	Stormwater pipes and associated installation are to comply with relevant NZ standards and the manufacturer,s requirements, be suitable for the catchment, and not less than 200mm diameter.	
12.	Sump grates shall be not less than 300mm x 300mm, be suitable for catchment, and vehicle lo	ading.
13.	Where an access falls towards a road, a sump is to be installed at the property boundary disch an approved outfall. Runoff is not to be concentrated so as to pond, flood, or cause erosion of adjacent property, or affect pedestrian use of footpaths.	
14.	Cut and fill batters are to be contained within the legal access, unless otherwise approved.	
15.	Adequate turning & parking areas for fire appliances and service vehicles shall be provided in th of fire hydrant and sewer pump stations located within or adjacent to a privateway.	e vicinity
	DOANI DDIV/ATE/M/AV DETAILS	FEB 202
UΓ	REAN PRIVATEWAY DETAILS	0.

Sheet 18 Vehicle Crossing - Residential



	09 553 3660			CLIENT:	PROJECT DESCRIPTION:		APPROVED BY:
	os@coreeng.nz			Esnem Properties Ltd	6 Bisset Road Development		
	vel 1, 31 Vine Street,				o Disser Ruad Development	ORIGINAL:	SCALE:
	· · · · · ·					A2	
ENGINEERING SOLUTIONS	hangarei 0110			LOCATION:	SHEET TITLE:	AJ	
	01	10/9/21	6 Bisset Development	6 Bisset Road, Kaikohe,	Engineering Standards - Vehicle Crossing 02	FILE: 22-0230	SHEET:
Structural   Geotechnical   Civil	Re	ev Date	Notes	Northland	Engineering Standards - Venicle Crossing 02	22-0230	ED08

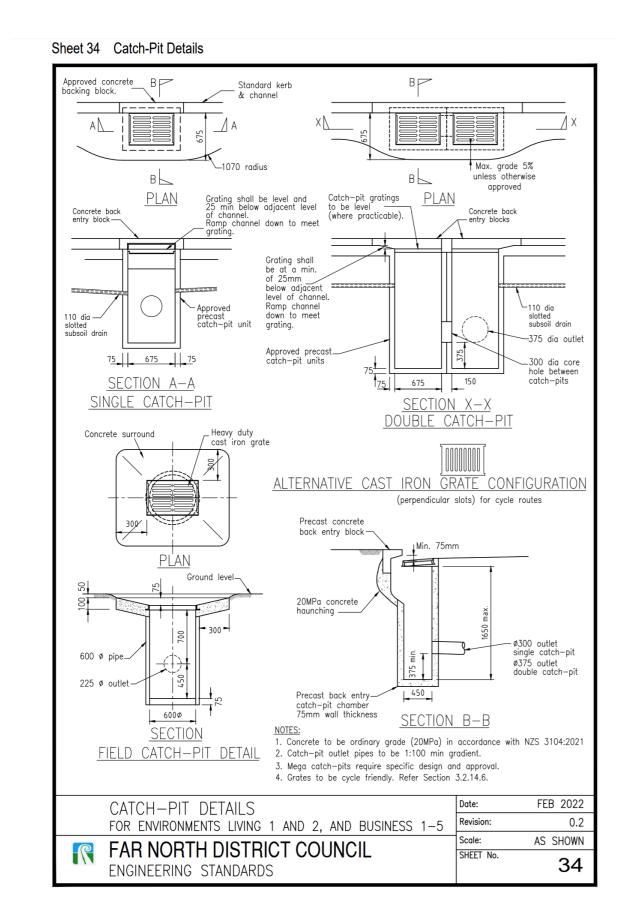

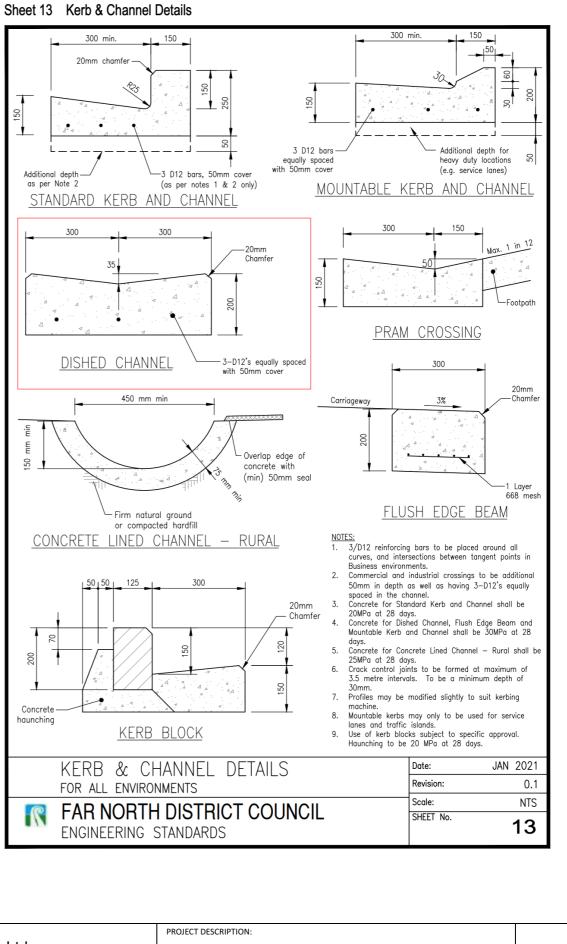

	T: 09 553 3660				CLIENT:	PROJECT DESCRIPTION:
Consulting	jobs@coreeng.nz				Esnem Properties Ltd	6 Bisset Road Development
Engineers	Level 1, 31 Vine Street,	$\vdash$			-	
	Whangarei 0110	$\vdash$			LOCATION:	SHEET TITLE:
ENGINEERING SOLUTIONS	0	01 1	10/9/21	6 Bisset Development	6 Bisset Road, Kaikohe,	
Structural   Geotechnical   Civil					Northland	Engineering Standards - Kerb
		Rev D	Jate	Notes	nortinariu	

APPROVED BY:
SCALE.

Kerb/channel & Cesspit

A3 FILE: 22-0230

ORIGINAL

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Legend:	
10,000L detention tanks	(т)
225mm Existing SS line	
100mm Proposed SS line	NSS
150mm Proposed SW line	
Existing water supply	——————————————————————————————————————
New water supply	NSW
Water supply rider main extension	
Proposed SW Cesspit	CP
Existing water meter	WM
Proposed water meter	WM
Existing hydrant	B
Ex. water supply valve	

#### PRIVATE ROAD:

1. Hardfill is to be placed where pipelines cross or where lines cross carriageways 2. Urban Cross sections to comply with FNDC Engineer Standards (sheet 18, dated Jan 2021) 3. Private road kerb detail as per FNDC Engineer Standards (sheet 13, dated Jan 2021). 4. Private Road cross section to comply with FNDC Engineer Standards.

5. Concrete shall be 30.0 MPa through crossings 6. Expansion joints shall be made at 3.5m intervals or

closer as need arises 7. The Engineer must view the subgrade prior to the application of the bedding material.

8. The boxing for the private road is to be inspected prior to the pouring of the concrete. Contact the Engineer on 09 553 3660, at least 48 hours prior to inspection.

#### VEHICLE CROSSING:

1. Minimum crossing dimensions as per FNDC Engineer Standards - Hardfill is to be placed where pipelines cross or where lines cross carriageways.

#### WATER SUPPLY:

1. Hardfill is to be placed where pipelines cross or where lines cross carriageways 2. Urban Cross sections to comply with FNDC Engineer Standards (sheet 18, dated Jan 2021) 3. Private road kerb detail as per FNDC Engineer

Standards (sheet 13, dated Jan 2021).

4. Private Road cross section to comply with FNDC Engineer Standards.

5. Concrete shall be 30.0 MPa through crossings

6. Expansion joints shall be made at 3.5m intervals or closer as need arises

7. The Engineer must view the subgrade prior to the


application of the bedding material

8. The boxing for the private road is to be inspected prior to the pouring of the concrete. Contact the Engineer on 09

553 3660, at least 48 hours prior to inspection.



ız Street,				Esnem Properties Ltd	6 Bisset Road Development
)				LOCATION:	SHEET TITLE:
	01	10/9/21	6 Bisset Development	6 Bisset Road, Kaikohe,	Service Layout 01
	Rev	Date	Notes	Northland	Service Layout 01

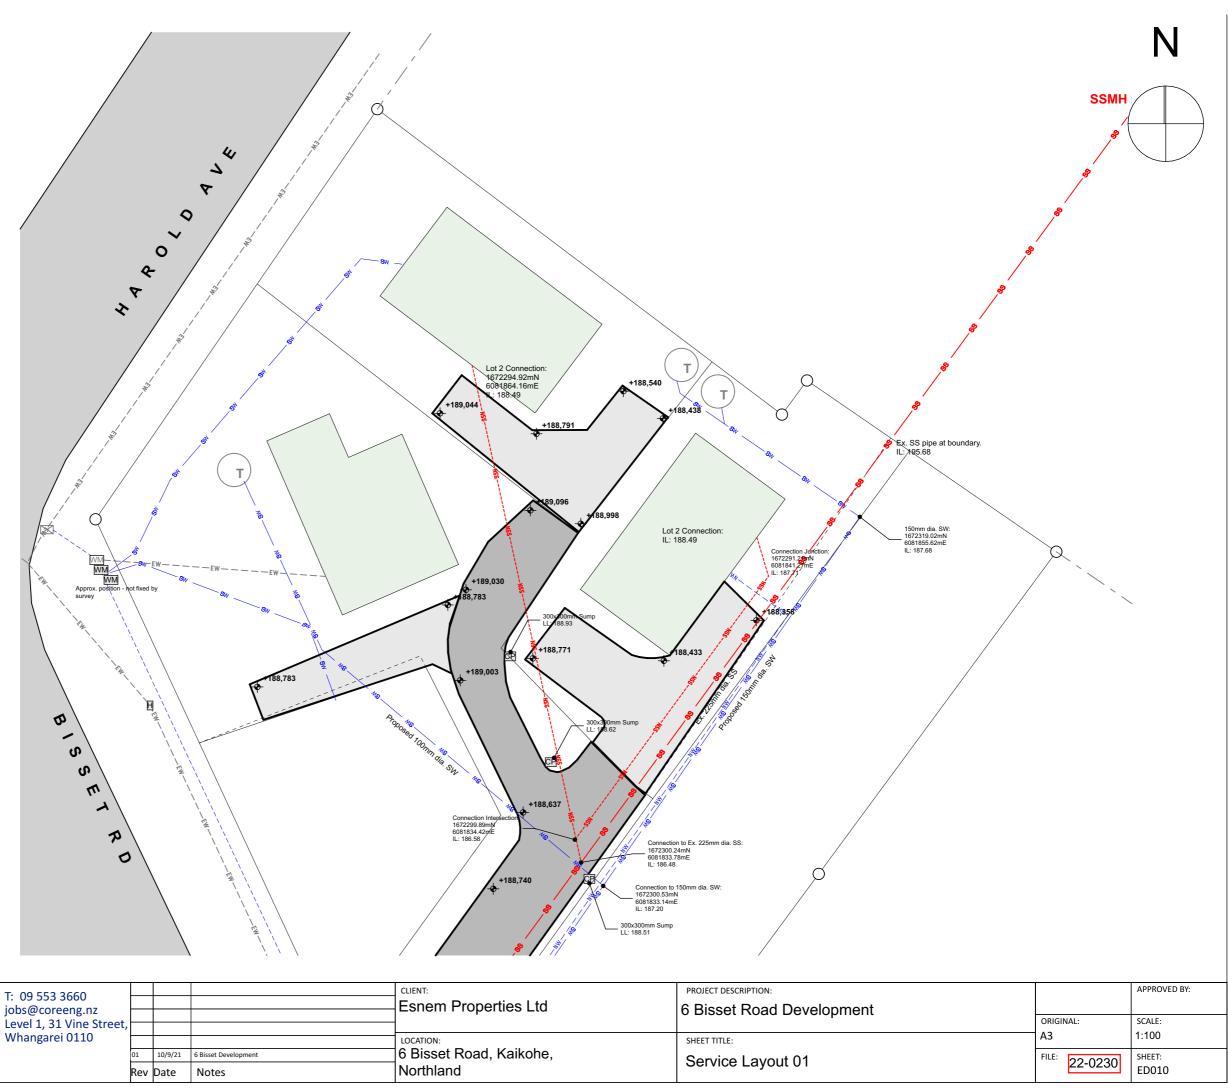

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#### Legend:

Legend.	$\frown$
10,000L detention tanks	(т)
225mm Existing SS line	
100mm Proposed SS line	NSS
150mm Proposed SW line	
Existing water supply	— — — — EW — — — –
New water supply	NSW
Water supply rider main extension	
Proposed SW Cesspit	CP
Existing water meter	WM
Proposed water meter	WM
Existing hydrant	Ħ
Ex. water supply valve	

#### PRIVATE ROAD:

1. Hardfill is to be placed where pipelines cross or

where lines cross carriageways 2. Urban Cross sections to comply with FNDC Engineer

Standards (sheet 18, dated Jan 2021)

3. Private road kerb detail as per FNDC Engineer Standards (sheet 13, dated Jan 2021).

4. Private Road cross section to comply with FNDC

Engineer Standards.

5. Concrete shall be 30.0 MPa through crossings 6. Expansion joints shall be made at 3.5m intervals or

closer as need arises 7. The Engineer must view the subgrade prior to the

application of the bedding material.

8. The boxing for the private road is to be inspected prior to the pouring of the concrete. Contact the Engineer on 09 553 3660, at least 48 hours prior to inspection.

#### VEHICLE CROSSING:

Minimum crossing dimensions as per FNDC Engineer Standards - Hardfill is to be placed where pipelines cross or where lines cross carriageways.

#### WATER SUPPLY:

1. Hardfill is to be placed where pipelines cross or where lines cross carriageways

2. Urban Cross sections to comply with FNDC Engineer Standards (sheet 18, dated Jan 2021)

3. Private road kerb detail as per FNDC Engineer Standards (sheet 13. dated Jan 2021).

4. Private Road cross section to comply with FNDC

Engineer Standards.

5. Concrete shall be 30.0 MPa through crossings 6. Expansion joints shall be made at 3.5m intervals or


closer as need arises

7. The Engineer must view the subgrade prior to the

application of the bedding material.

8. The boxing for the private road is to be inspected prior to the pouring of the concrete. Contact the Engineer on 09


553 3660, at least 48 hours prior to inspection.

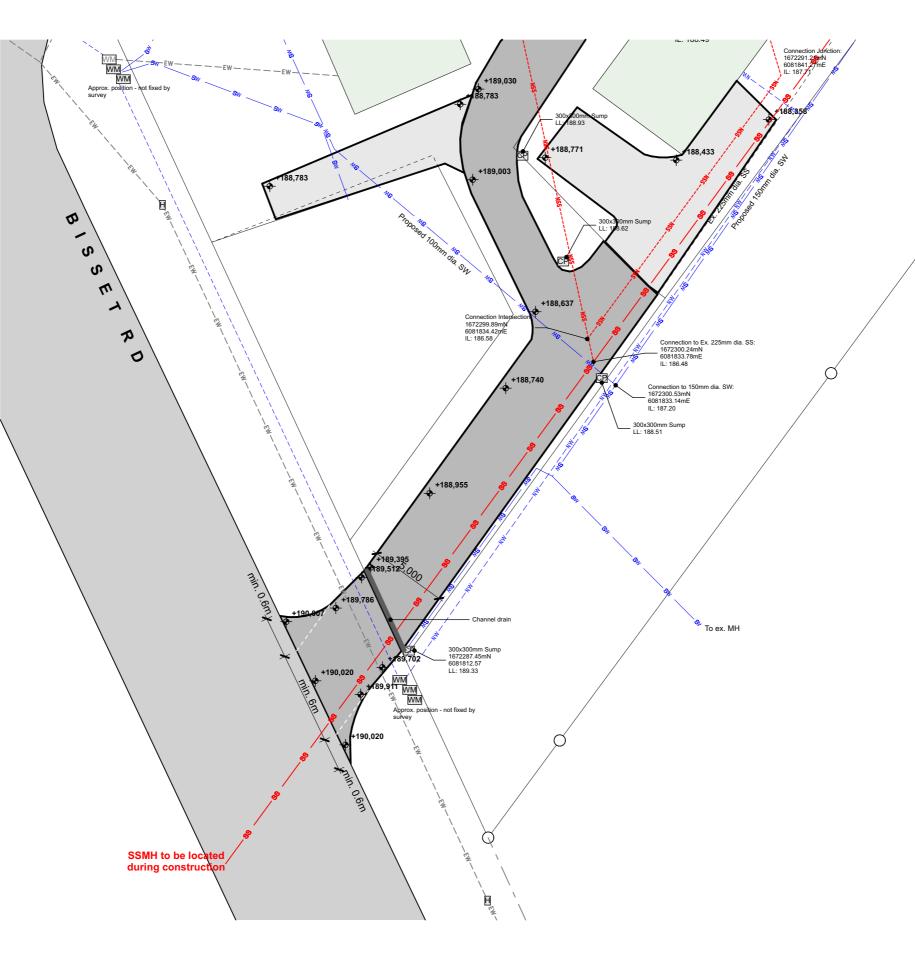


Consulting T: 09 553 3660 jobs@coreeng.nz			Esnem Properties Ltd	PROJECT DESCRIPTION: 6 Bisset Road Development		APPROVED BY:
Engineers Level 1, 31 Vine St	eet,				ORIGINAL:	SCALE:
ENGINEERING SOLUTIONS Whangarei 0110			LOCATION:	SHEET TITLE:	A3	1:100
Structural   Geotechnical   Civil		6 Bisset Development Notes	6 Bisset Road, Kaikohe, Northland	Service Layout 02	FILE: 22-0230	SHEET: ED011

Ν

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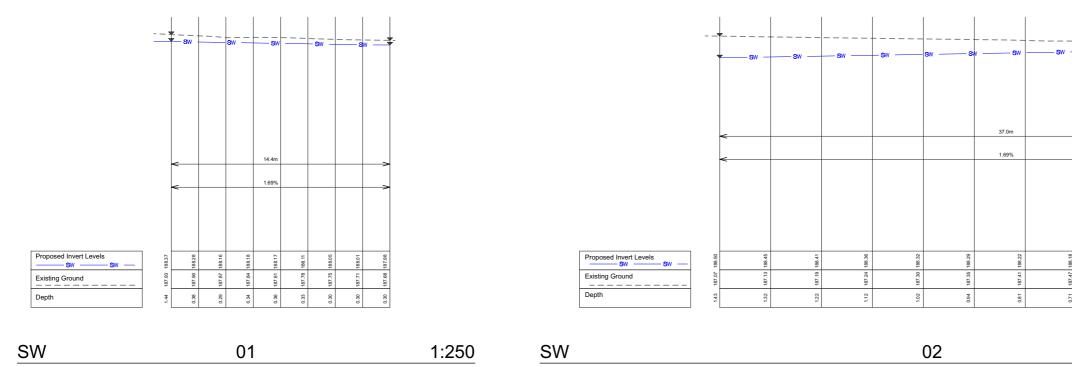


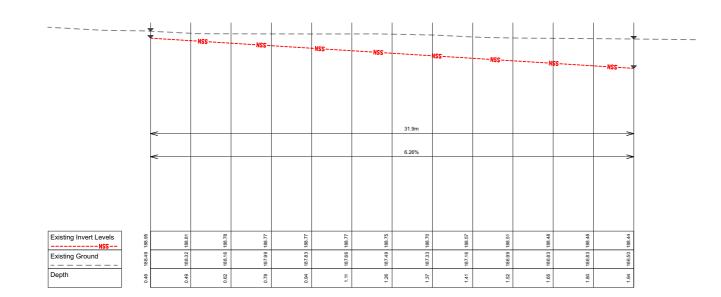
SS	01	1:250	SS	02
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CORE Consulting Engineers T: 09 553 3660 jobs@coreeng.nz Level 1, 31 Vine Street				CLIENT: Esnem Properties Ltd	PROJECT DESCRIPTION: 6 Bisset Road Developme
ENGINEERING SOLUTIONS Whangarei 0110	01	10/9/21	6 Bisset Development	LOCATION: 6 Bisset Road, Kaikohe,	SHEET TITLE:
Structural   Geotechnical   Civil	Rev	Date		Northland	SS01 & SS02 Long Section

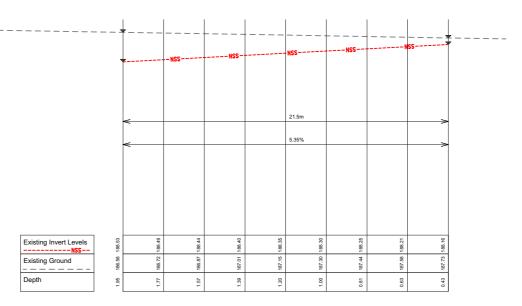1:250

ent		APPROVED BY:
	ORIGINAL:	SCALE:
	A3	1:250
ions	FILE: 22-0230	SHEET:
	0200	ED012



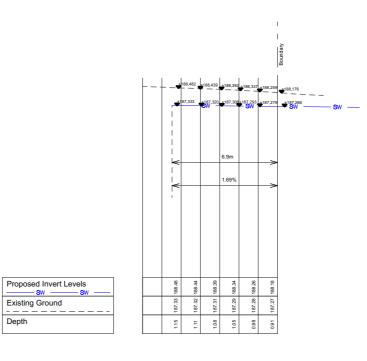



			SW	03	1:250			
	T: 09 553 3660			CLIENT:		PROJECT DESCRIPTION:		APPROVED BY:
Consulting Engineers	jobs@coreeng.nz			Esnem Properties Ltd		6 Bisset Road Development	ORIGINAL:	SCALE:
	Level 1, 31 Vine Street, Whangarei 0110			LOCATION:		SHEET TITLE:	A3	1:250
ENGINEERING SOLUTIONS	5	01 10/9/21	6 Bisset Development	6 Bisset Road, Kaikohe,		SW01, SW02 & SW03 Long Sections	FILE: 22-0230	SHEET:
Structural   Geotechnical   Civil		Rev Date	Notes	Northland			22-0230	SHEET: ED013


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- sw -	sw	Sw		sw\$
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				>
188.18	188.18	188.07	188.03	187.98
187.47	187.52	187.58	187.63	187.69
0.71	0.66	0.49	0.40	0.29

1:250

#### Sheet 31 Pipe Bedding and Backfill

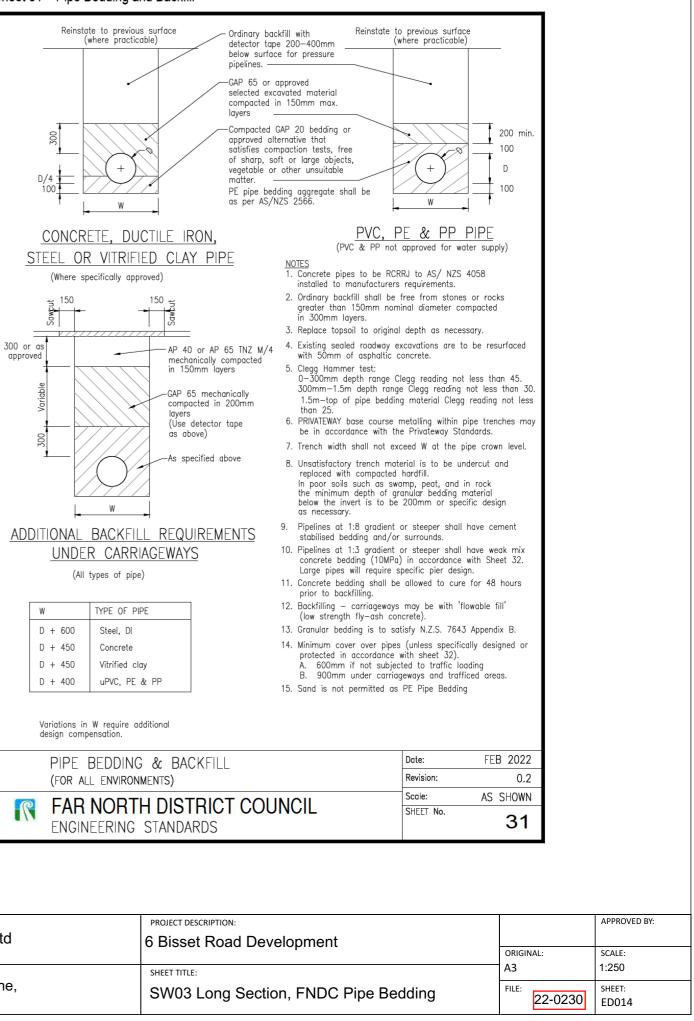


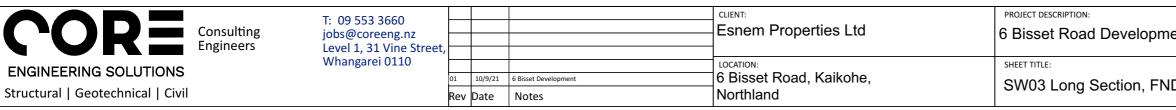


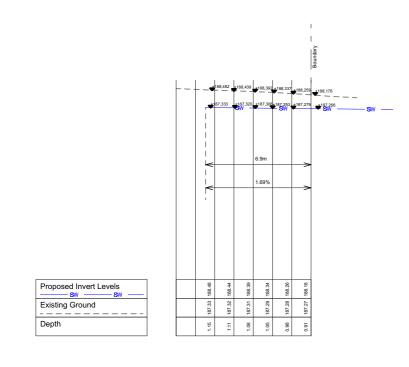

SW 03 1:250

#### Sheet 34 Catch-Pit Details

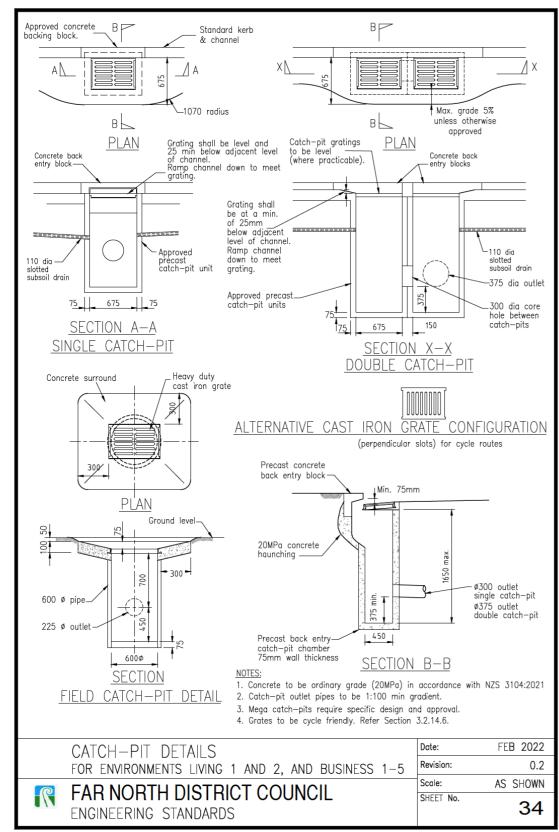

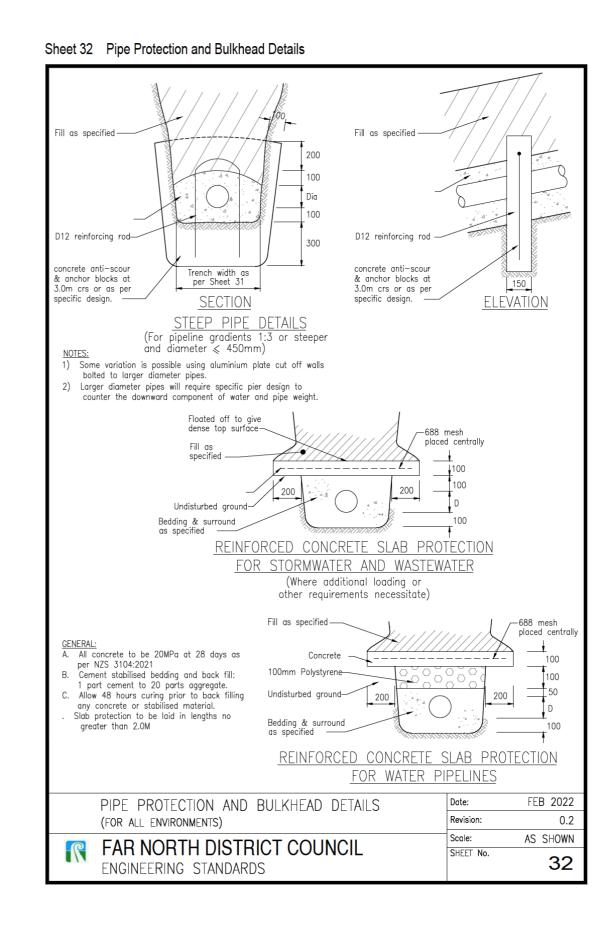

	T: 09 553 3660 jobs@coreeng.nz	CLIENT: Esnem Properties Ltd	PROJECT DESCRIPTION: 6 Bisset Road Development		APPROVED BY:
	Level 1, 31 Vine Street, Whangarei 0110	LOCATION:	SHEET TITLE:	ORIGINAL: A3	SCALE:
ENGINEERING SOLUTIONS Structural   Geotechnical   Civil	01 10/9/21 6 Bisset Development Rev Date Notes	6 Bisset Road, Kaikohe, Northland	Engineering Standards - Stormwater	FILE: 22-0230	SHEET: ED015

ESNEM PROPERTIES LIMITED

#### Far North District Council **Pre- Application Meeting Minutes**

Date:	22/11/24	
Time:	10:00-10:30am	
Location:	Conference call	
Attendance:		
Far North Distri	ct Council	Rinku Meshra
		Salamasina Brown
		Smitha Bhaskar
Esnem Properti	es Ltd	Shane Tregidga (ST)

#### **Discussion Points**

- This application looks to approve what was already approved (RC2300042, stamped 15/9/2020)
- Advice from the FNDC was given to apply for a RC Variation (adding a Lot back in to an previously approved Scheme).
- FNDC stated that no new relocatable housing rules have been created since the initial RC was approved (2020).
- FNDC confirmed that the Assessment of Environmental Effects must be updated to align with the latest planning criteria and regulations.
- FNDC confirmed an updated scheme plan will be required for the submission.
- FNDC confirmed to submit all previous Engineer approvals, 223 and 224c certificates. ST confirmed that no berm works will be required as Lot 5 already has services (completed in Stage 1 of subdivision. FNDC stated that engineer approvals will be required for services on newlt created Lot 5.
- FNDC confirmed that we cannot build over "Easement I"




Layout ID	Layout Name	Issue ID	Issued Date
RC01	Cover Sheet	G	25/05/22.
RC02	Site: FNUP Compliance Schedule	D	11/09/20,
RC03	Site Bulk & Location	D	11/09/20,
RC04	Vehicle Tracking/Landscape Plan & Critical Point Sections	G	25/05/22,
RC05	Perspectives	А	22/07/20,
RC06	Site Plan: Scheme Plan (Stage 1)	G	25/05/22,
RC07	Silt Fence & Planting Plan	E	27/04/22,
- RC08	Site Plan: Scheme Plan (Stage 2)	G	25/05/22,

# 6 Bisset Road, Kaikohe - Resource Consent

**Combined Subdivision / Land Use Consent Application** 





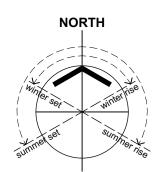

## **GENERAL NOTES**

0.1 Contractor to verify all dimensions and condition on site before commencing work.
0.2 Work only from figured dimensions. In the even a discrepancy consult the Architect.
0.3 The drawings are to be read in conjunction with Specification.
0.4 If in doubt, consult the Architect.

RevID	ChID	Revision	Date
А			22/07/20
В	B-01	Boundary Setout plan added to set	19/08/20
С			27/08/20
D	D-05	Issue Schedule updated	11/09/20
E	E-02	Issue Schedule updated (Rev E)	27/04/22
E	F-02	Issue Schedule updated (Rev F)	27/04/22
F	F-03	Issue Schedule updated (Rev F)	27/04/22
G	G-02	Issue Schedule Updated (Issue G)	25/05/22

P. 021 250 6671 E. esnempropertiesItd@gmail.com

title **Esnem Properties Ltd** 

**Proposed Subdivision** 6 Bisset Road

Kaikohe Northland sheet title **RC Submission** 

**Cover Sheet** 

drawn ST

scale As marked at A1


printed Wednesday, 25 May 2022

**RC01** 


sheet no.


G


Updated Vehicle Tracking/Landscape I SONAL/Shane/PERSONAL/ESNEM/6 bisset/Archi Files/RC/220427 6 Bisset RC Set\_Issue G.pln

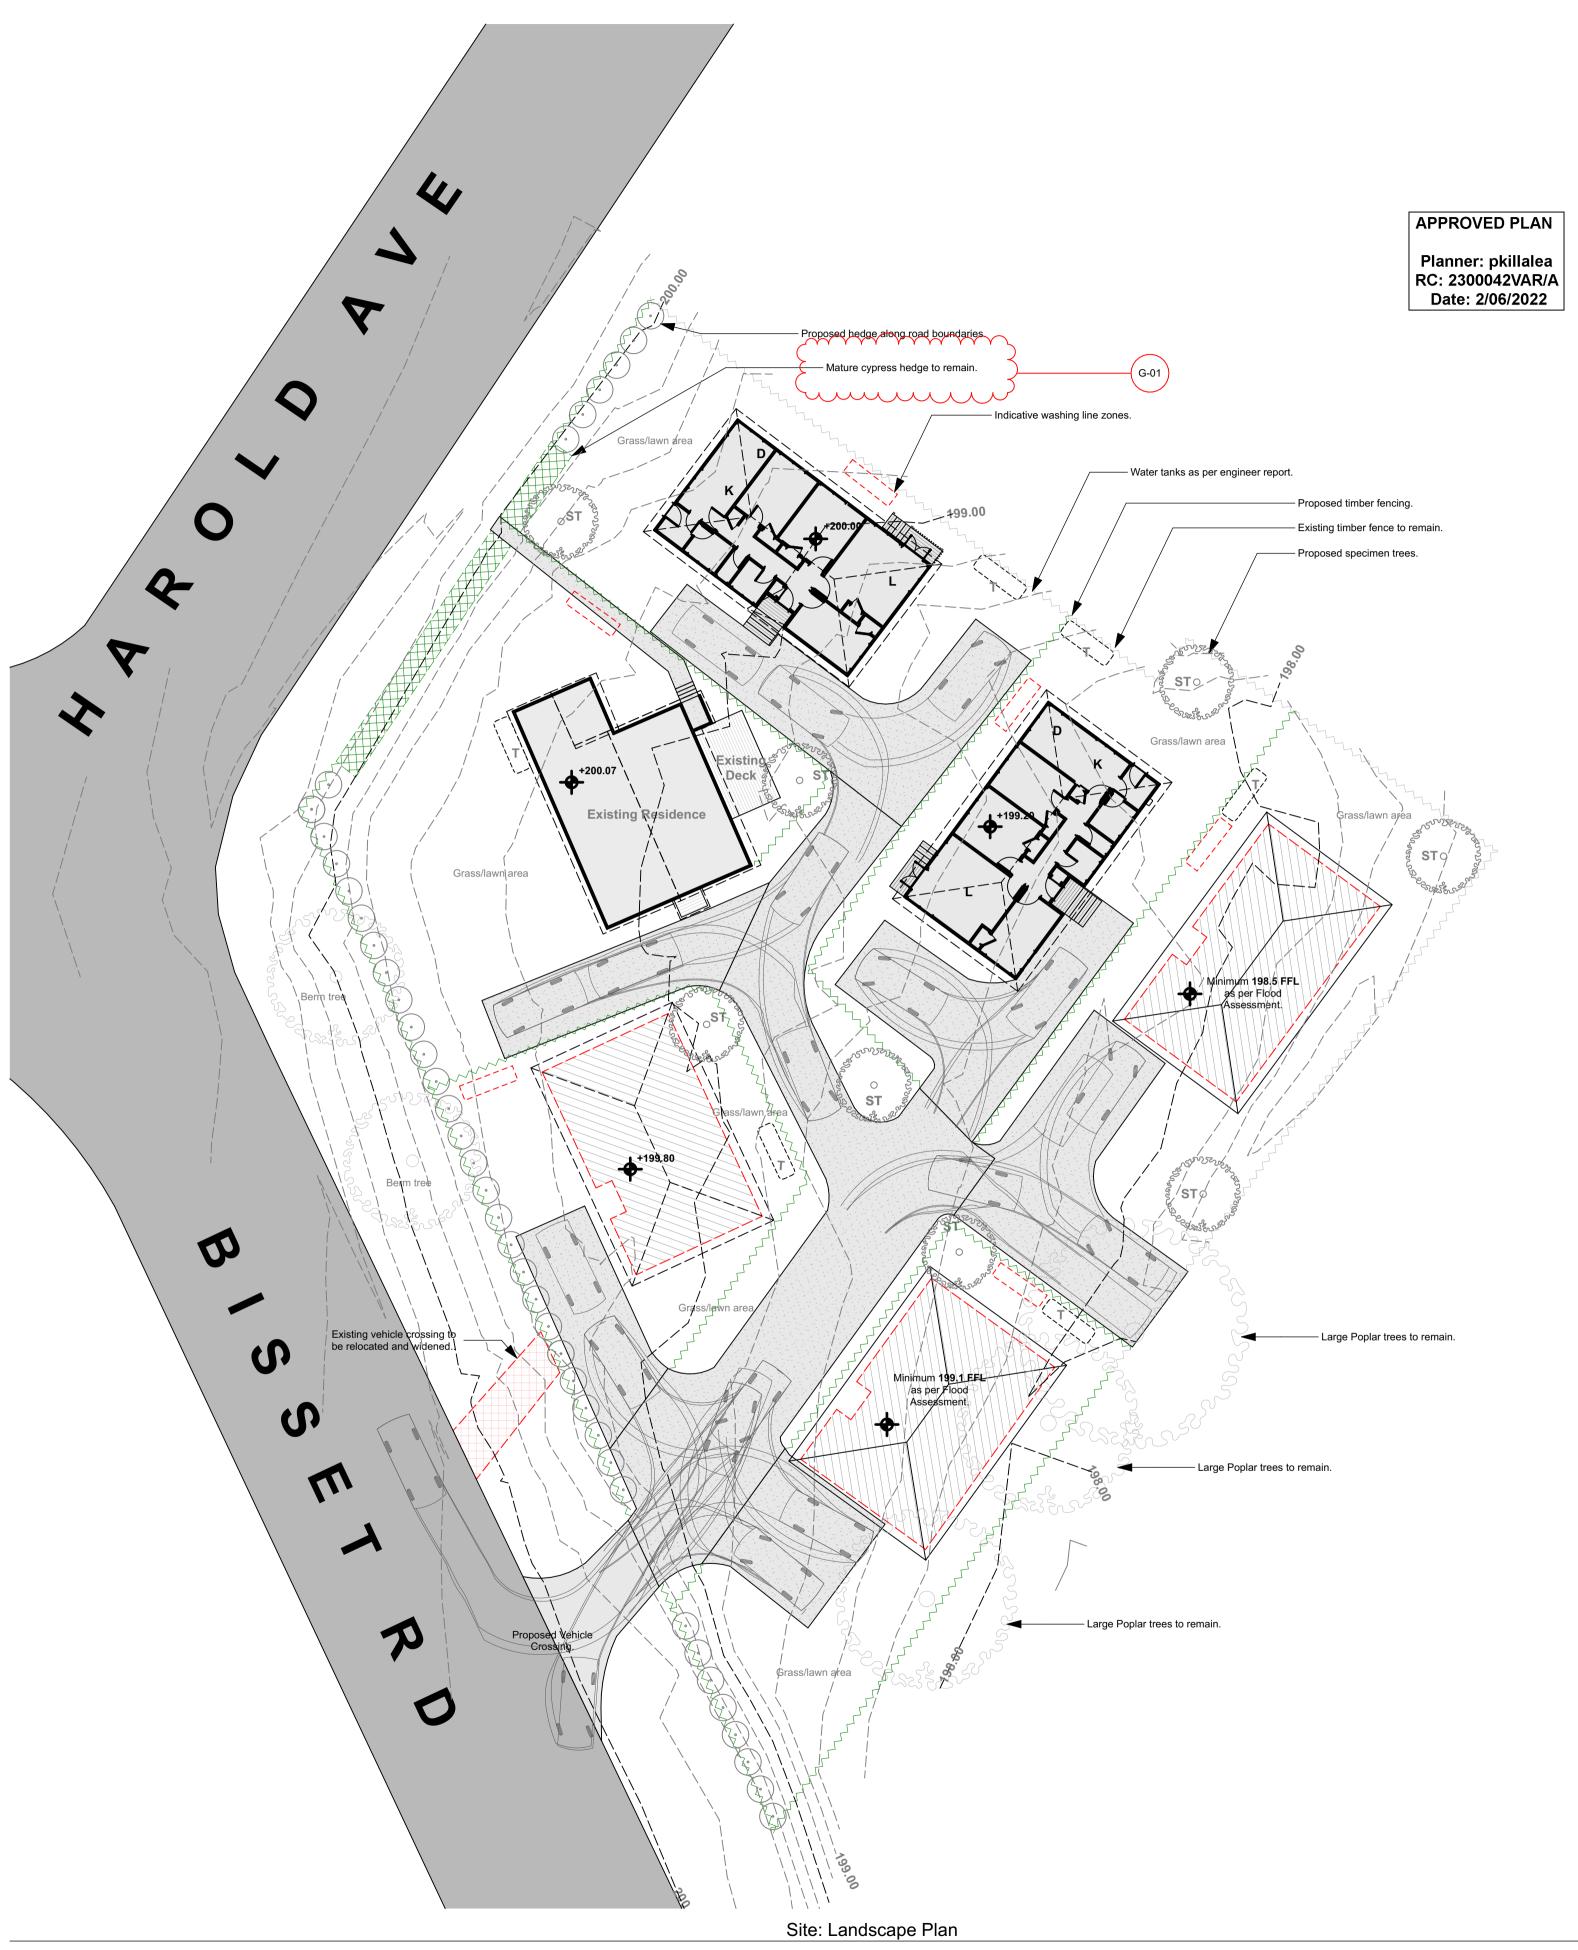



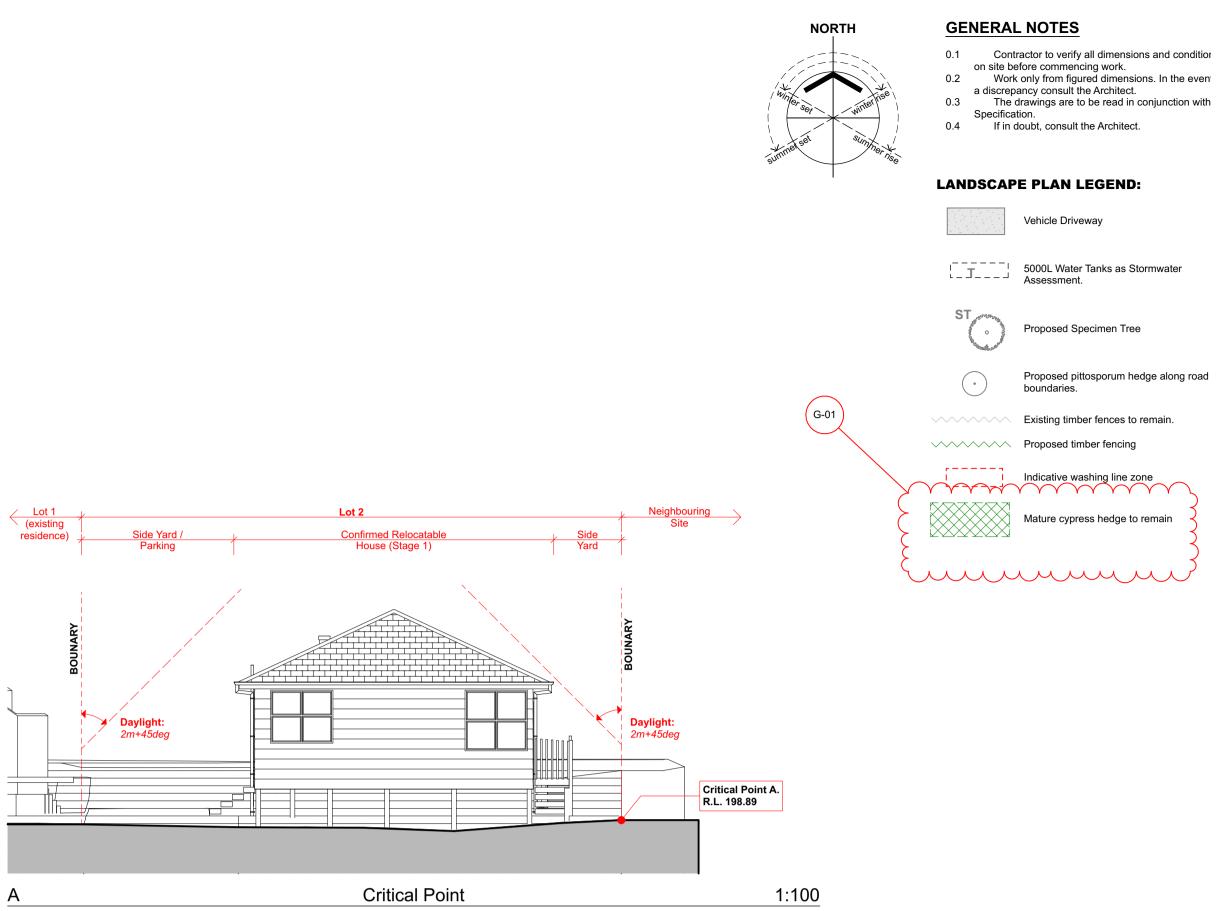

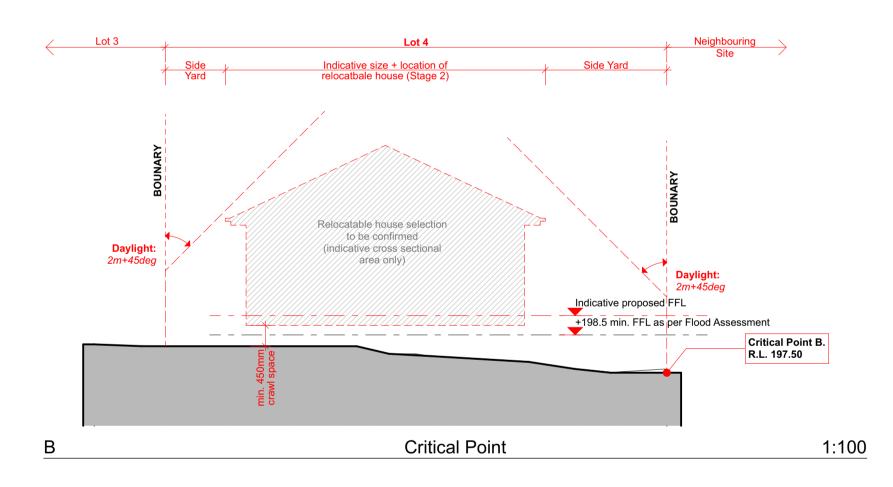

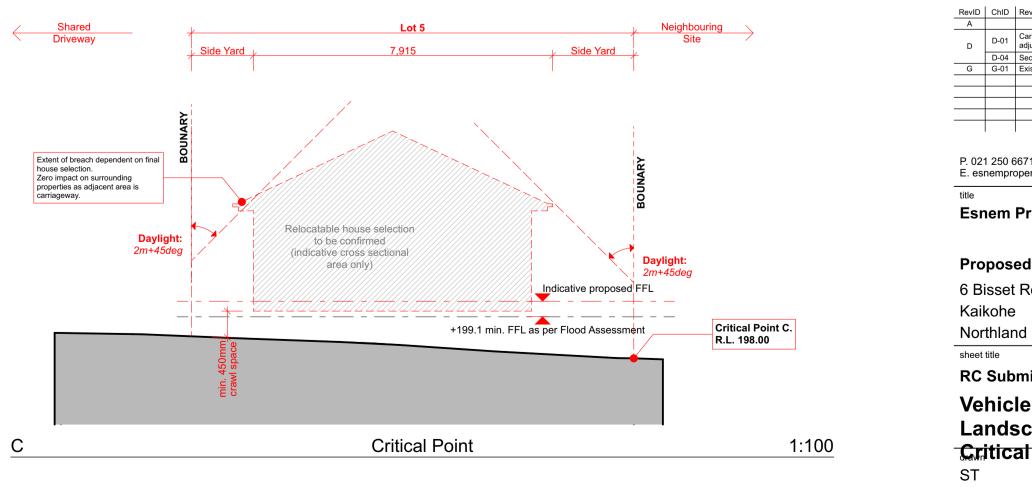

1:200

RevID	ChID	Revision	Date
А			22/07/20
D	D-01	Carriageway updates / boundary adjustments	11/09/20
	D-04	Section C updated	]
G	G-01	Existing cypress hedge to remain	25/05/22
	•	•	
D 02	1 250 0	2674	

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**Esnem Properties Ltd** 

Proposed Subdivision 6 Bisset Road Kaikohe


sheet title **RC Submission** 

Vehicle Tracking/ Landscape Plan & **Critical Point Sections** scale


As marked at A1

printed Wednesday, 25 May 2022 Updated Vehicle Tracking/Landscape I SONAL/Shane/PERSONAL/ESNEM/6 bisset/Archi Files/RC/220427 6 Bisset RC Set\_Issue G.pln

issue G

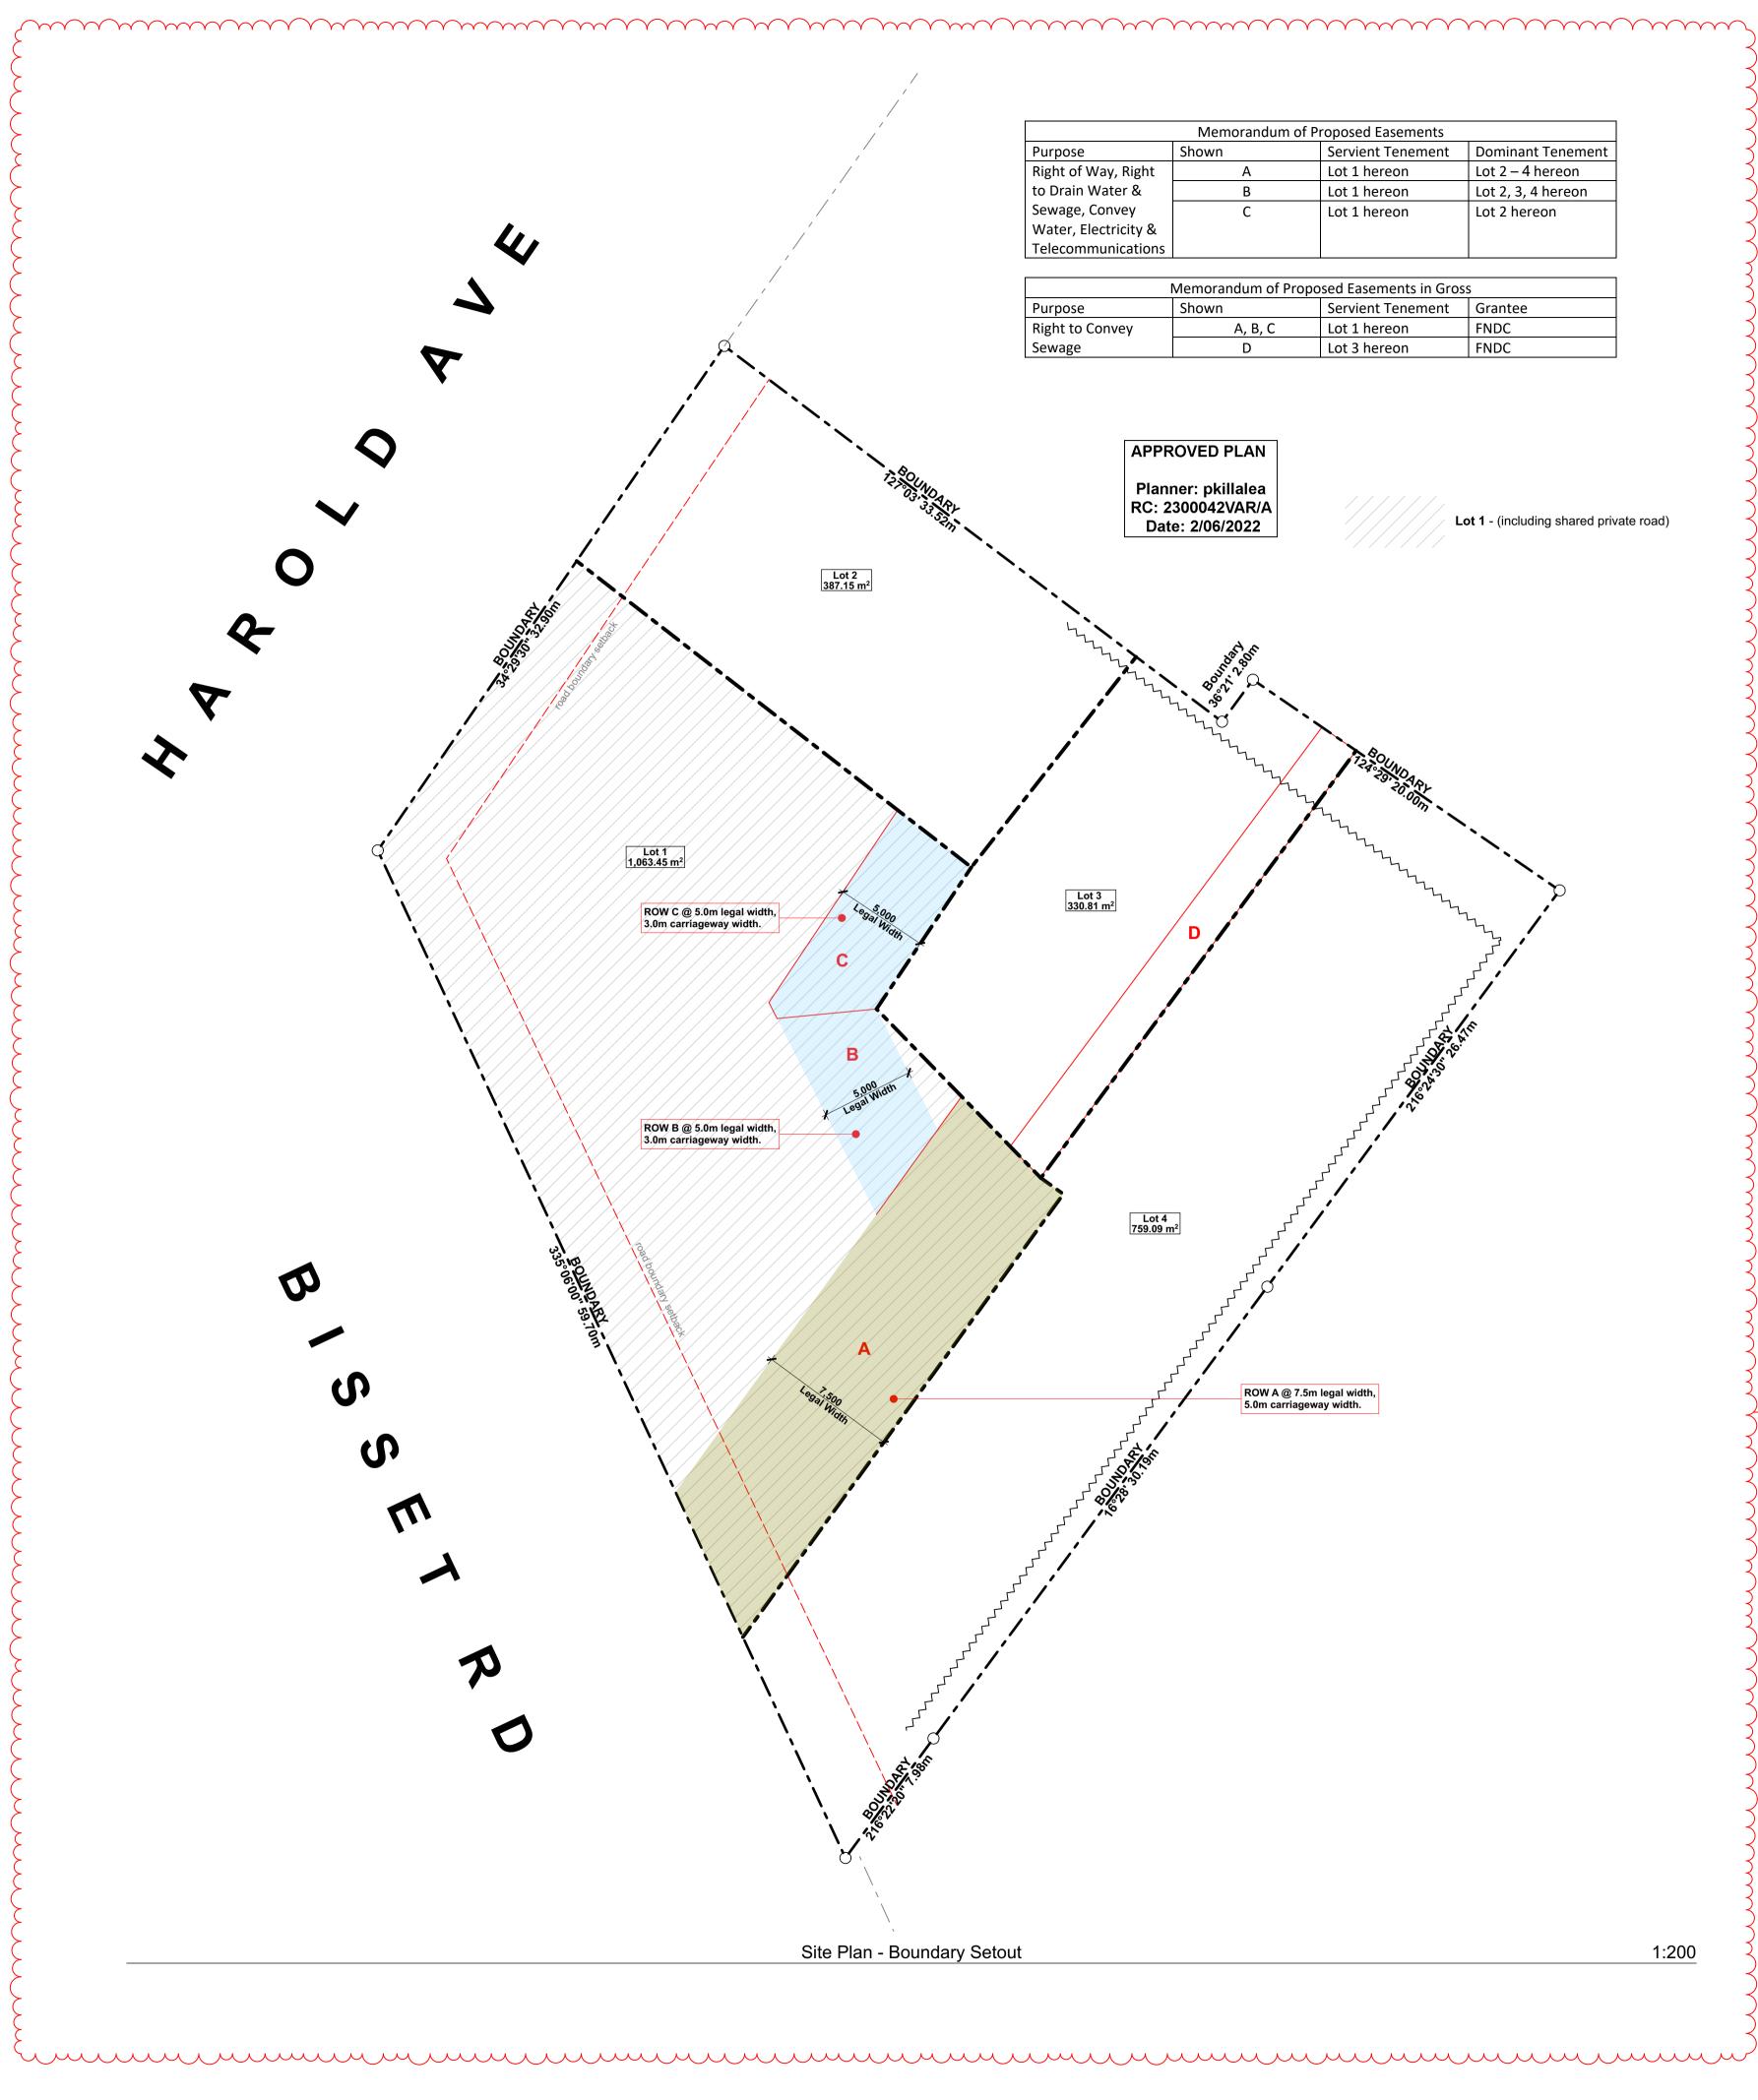

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## GENERAL NOTES
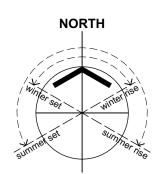
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RevID	ChID	Revision	Date
В	B-01	Boundary Setout plan added to set	19/08/20
С	C-01	Easement schedule added	27/08/20
D	D-01	Carriageway updates / boundary adjustments	11/09/20
F	F-01	Stages 1 & 2 identified on Scheme Plan	27/04/22
G	G-03	Updated Scheme Plan - Stage 1	25/05/22

P. 021 250 6671 E. esnempropertiesItd@gmail.com

title **Esnem Properties Ltd** 

## **Proposed Subdivision**

6 Bisset Road Kaikohe Northland sheet title

**RC Submission** Site Plan: Scheme Plan (Stage 1)

drawn

G-03

ST scale As marked at A1


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RC06 printed Wednesday, 25 May 2022


Updated Vehicle Tracking/Landscape I SONAL/Shane/PERSONAL/ESNEM/6 bisset/Archi Files/RC/220427 6 Bisset RC Set\_Issue G.pln

issue

G



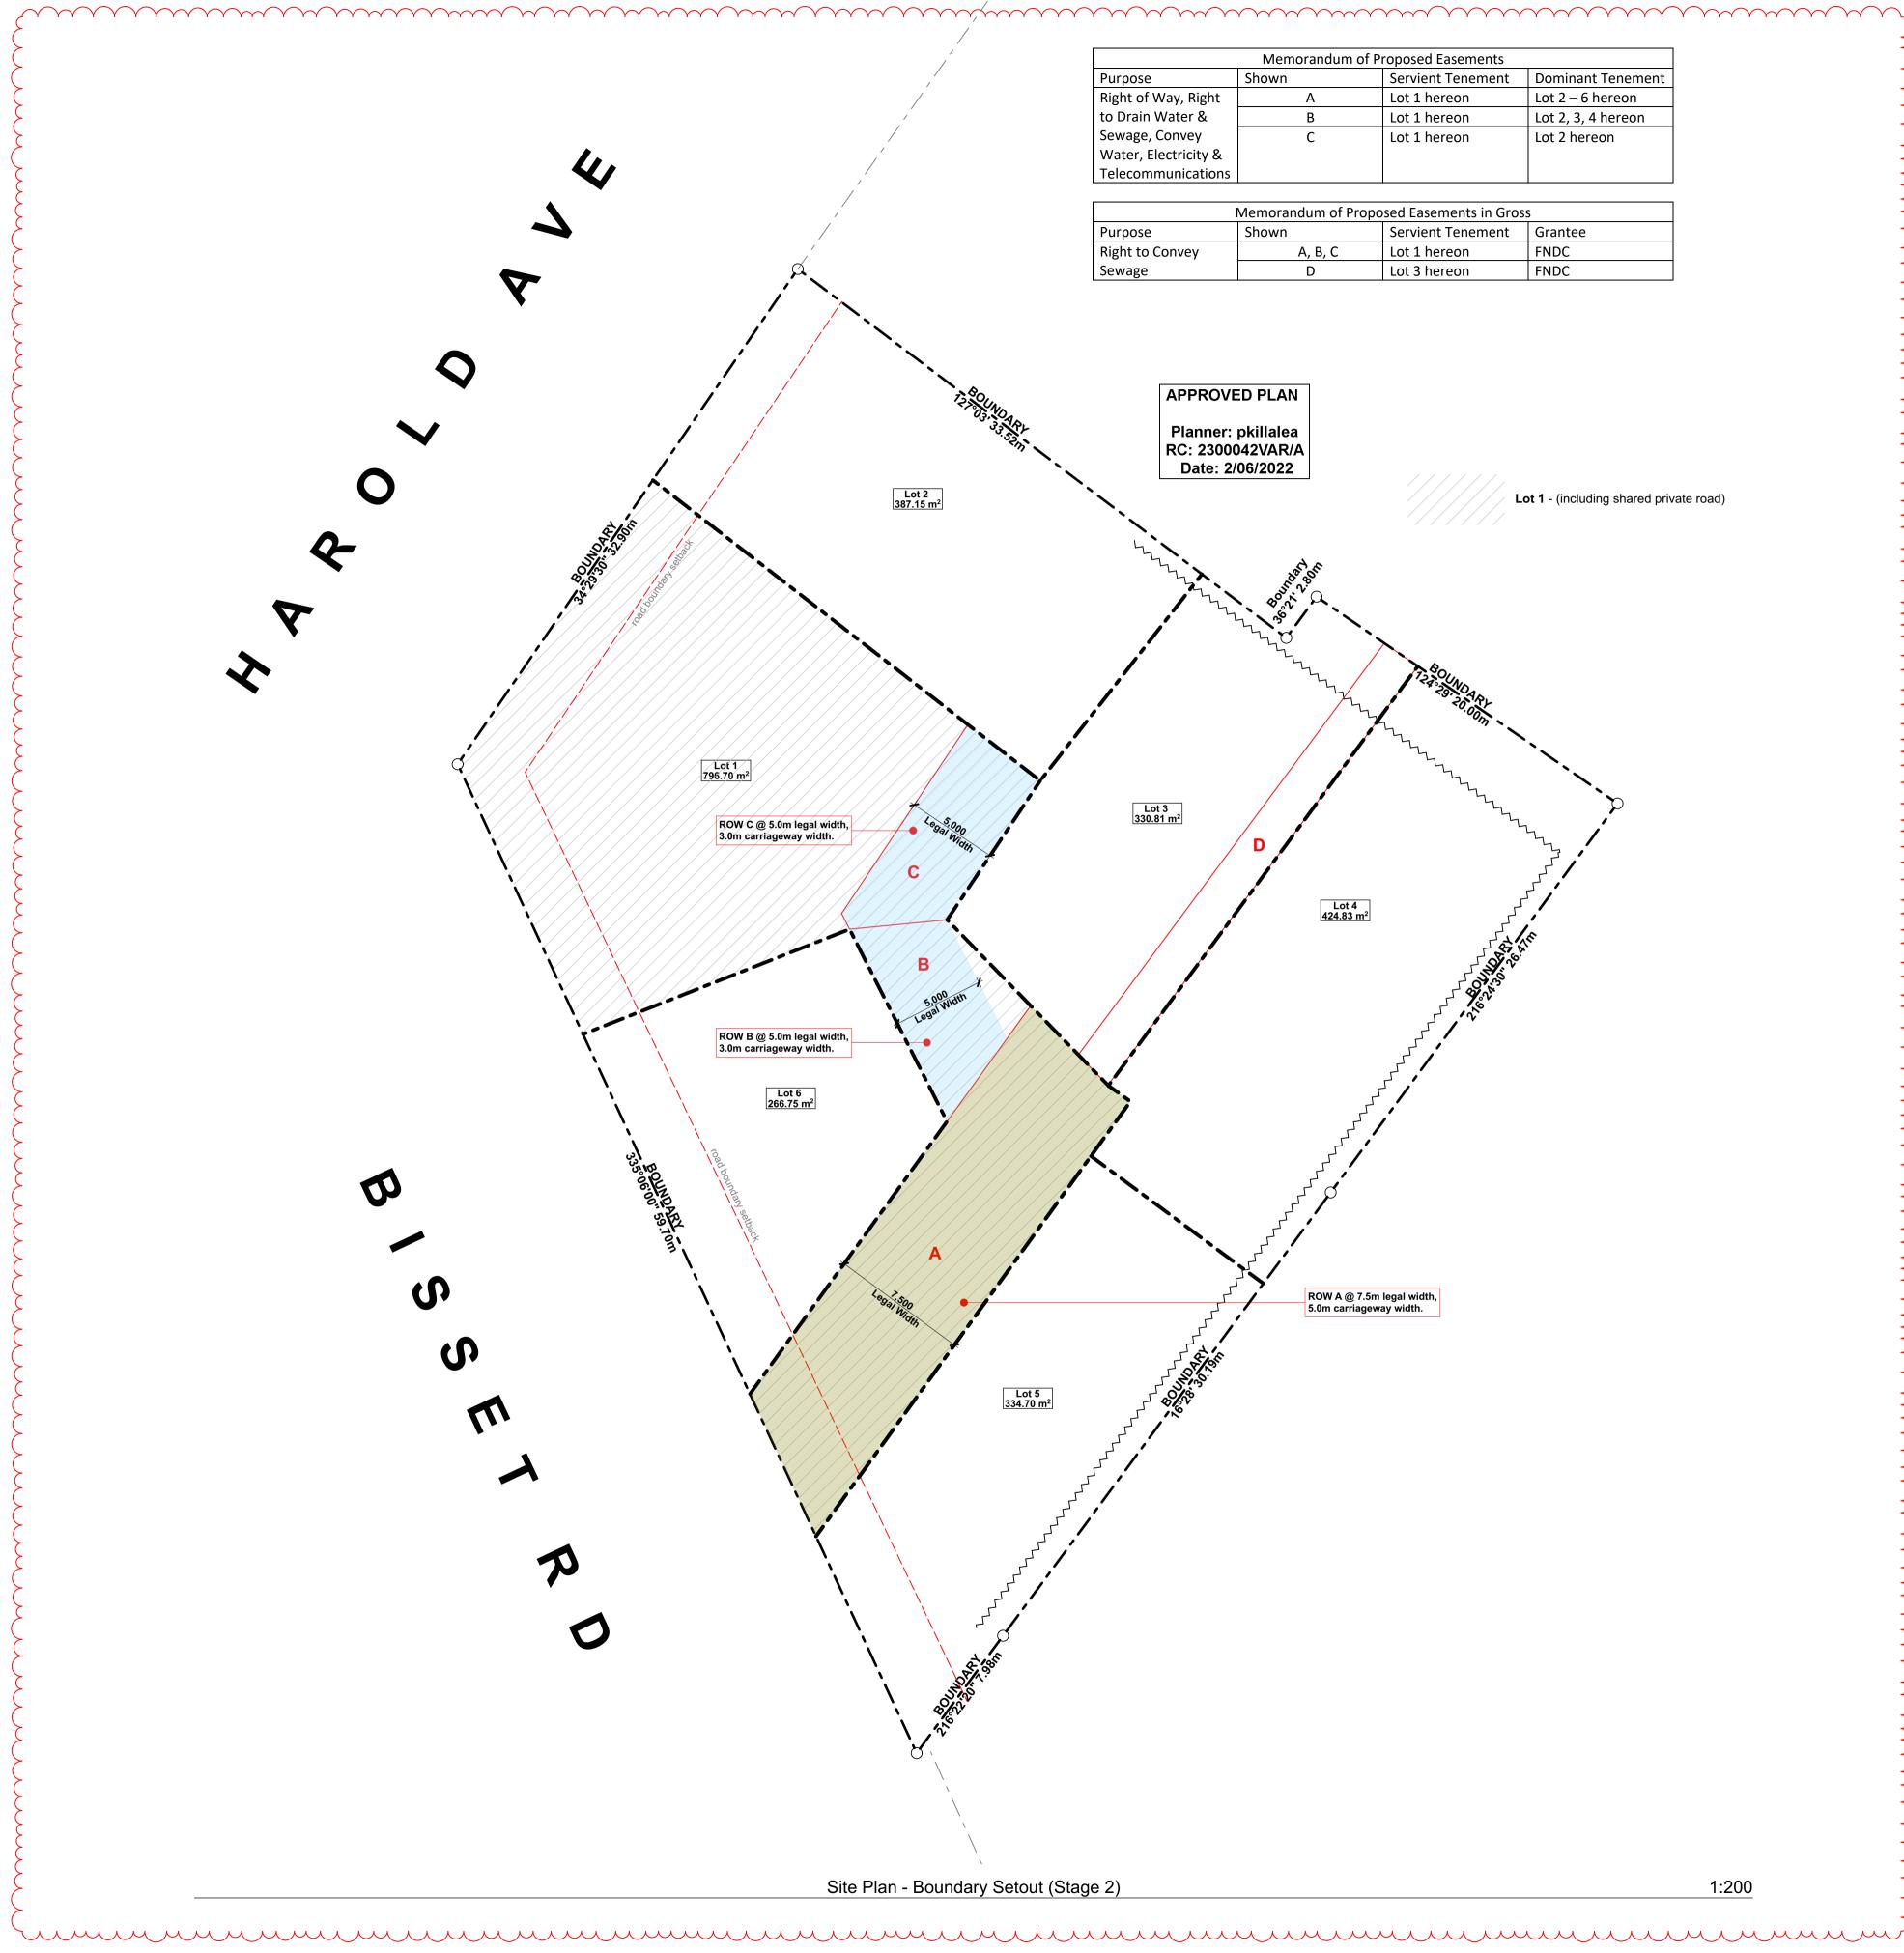

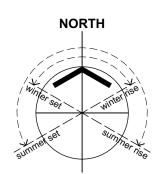

## GENERAL NOTES

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-G-04

## RevID Chil New Scheme Plan -\_\_\_\_\_ -----\_\_\_\_\_ \_\_\_\_\_ \_\_\_\_\_

P. 021 250 6671 E. esnempropertiesItd@gmail.com

title **Esnem Properties Ltd** 

## **Proposed Subdivision** 6 Bisset Road

Kaikohe Northland sheet title

## **RC Submission** Site Plan: Scheme Plan (Stage 2)

drawn ST

sheet no.

scale As marked at A1

RC08

G printed Wednesday, 25 May 2022

issue


Updated Vehicle Tracking/Landscape I SONAL/Shane/PERSONAL/ESNEM/6 bisset/Archi Files/RC/220427 6 Bisset RC Set\_Issue G.pln

Sheet Inc	lex			
Layout II	D Layout Name	ls	sue ID Issued Date	e )
RC0		D	11/09/20,	
RC0	2 Site: FNUP Compliance Schedule	D	11/09/20,	$\prec$
RC0	3 Site Bulk & Location	D	11/09/20,	$\sim$
RC04	Vehicle Tracking/Landscape Plan & Critical Point Sections	D	11/09/20,	$\prec$
RC0	5 Perspectives	А	22/07/20,	~ ~
RC0	S Site Plan: Boundary Setout	D	11/09/20,	

# 6 Bisset Road, Kaikohe - Resource Consent

**Combined Subdivision / Land Use Consent Application** 



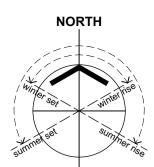

## **GENERAL NOTES**

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  0.3 The drawings are to be read in conjunction with Specification.
  0.4 If in doubt, consult the Architect.



RevID	ChID	Revision	Date
А			22/07/20
В	B-01	Boundary Setout plan added to set	19/08/20
С			27/08/20
D	D-05	Issue Schedule updated	11/09/20

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**Esnem Properties Ltd** 

**Proposed Subdivision** 6 Bisset Road Kaikohe Northland sheet title

**RC Submission Cover Sheet** 

drawn ST

title

scale As marked at A1 sheet no.

# **RC01**

## printed Friday, 11 September 2020 **Resource Consent**

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D




	complies	complies	complies	complies	complies	complies	n/a
					does not comply	does not comply	,
neighbour / external	complies	complies	complies	complies	(dependent on final house selection)	(dependent on final house selection)	n/a
Site Area	796.7	387.2	330.8	424.8	334.7	266.8	2541
Impervious Area	367.6	183.7	173.9	193.6	139.6	140.1	1223.0
Percentage	46.1%	47.4%	52.5%	45.6%	41.7%	52.5%	48.1%
	complies	complies	complies	complies	complies	complies	n/a
Site Area	796.7	387.2	330.8	424.8	334.7	266.8	2541
Building Coverage	92.8	92.7	92.7	approx. 95	approx. 95	approx. 95	approx. 563.2
Percentage	11.6%	23.9%	28.0%	22.3%	28.3%	35.6%	22.1%

. this drawing and the design it covers shall remain the property and copyright of the Architects .

**Resource Consent** 

'6 bisset/Archi Files/RC/200911 6 Bisset RC Set\_Issue D.pln

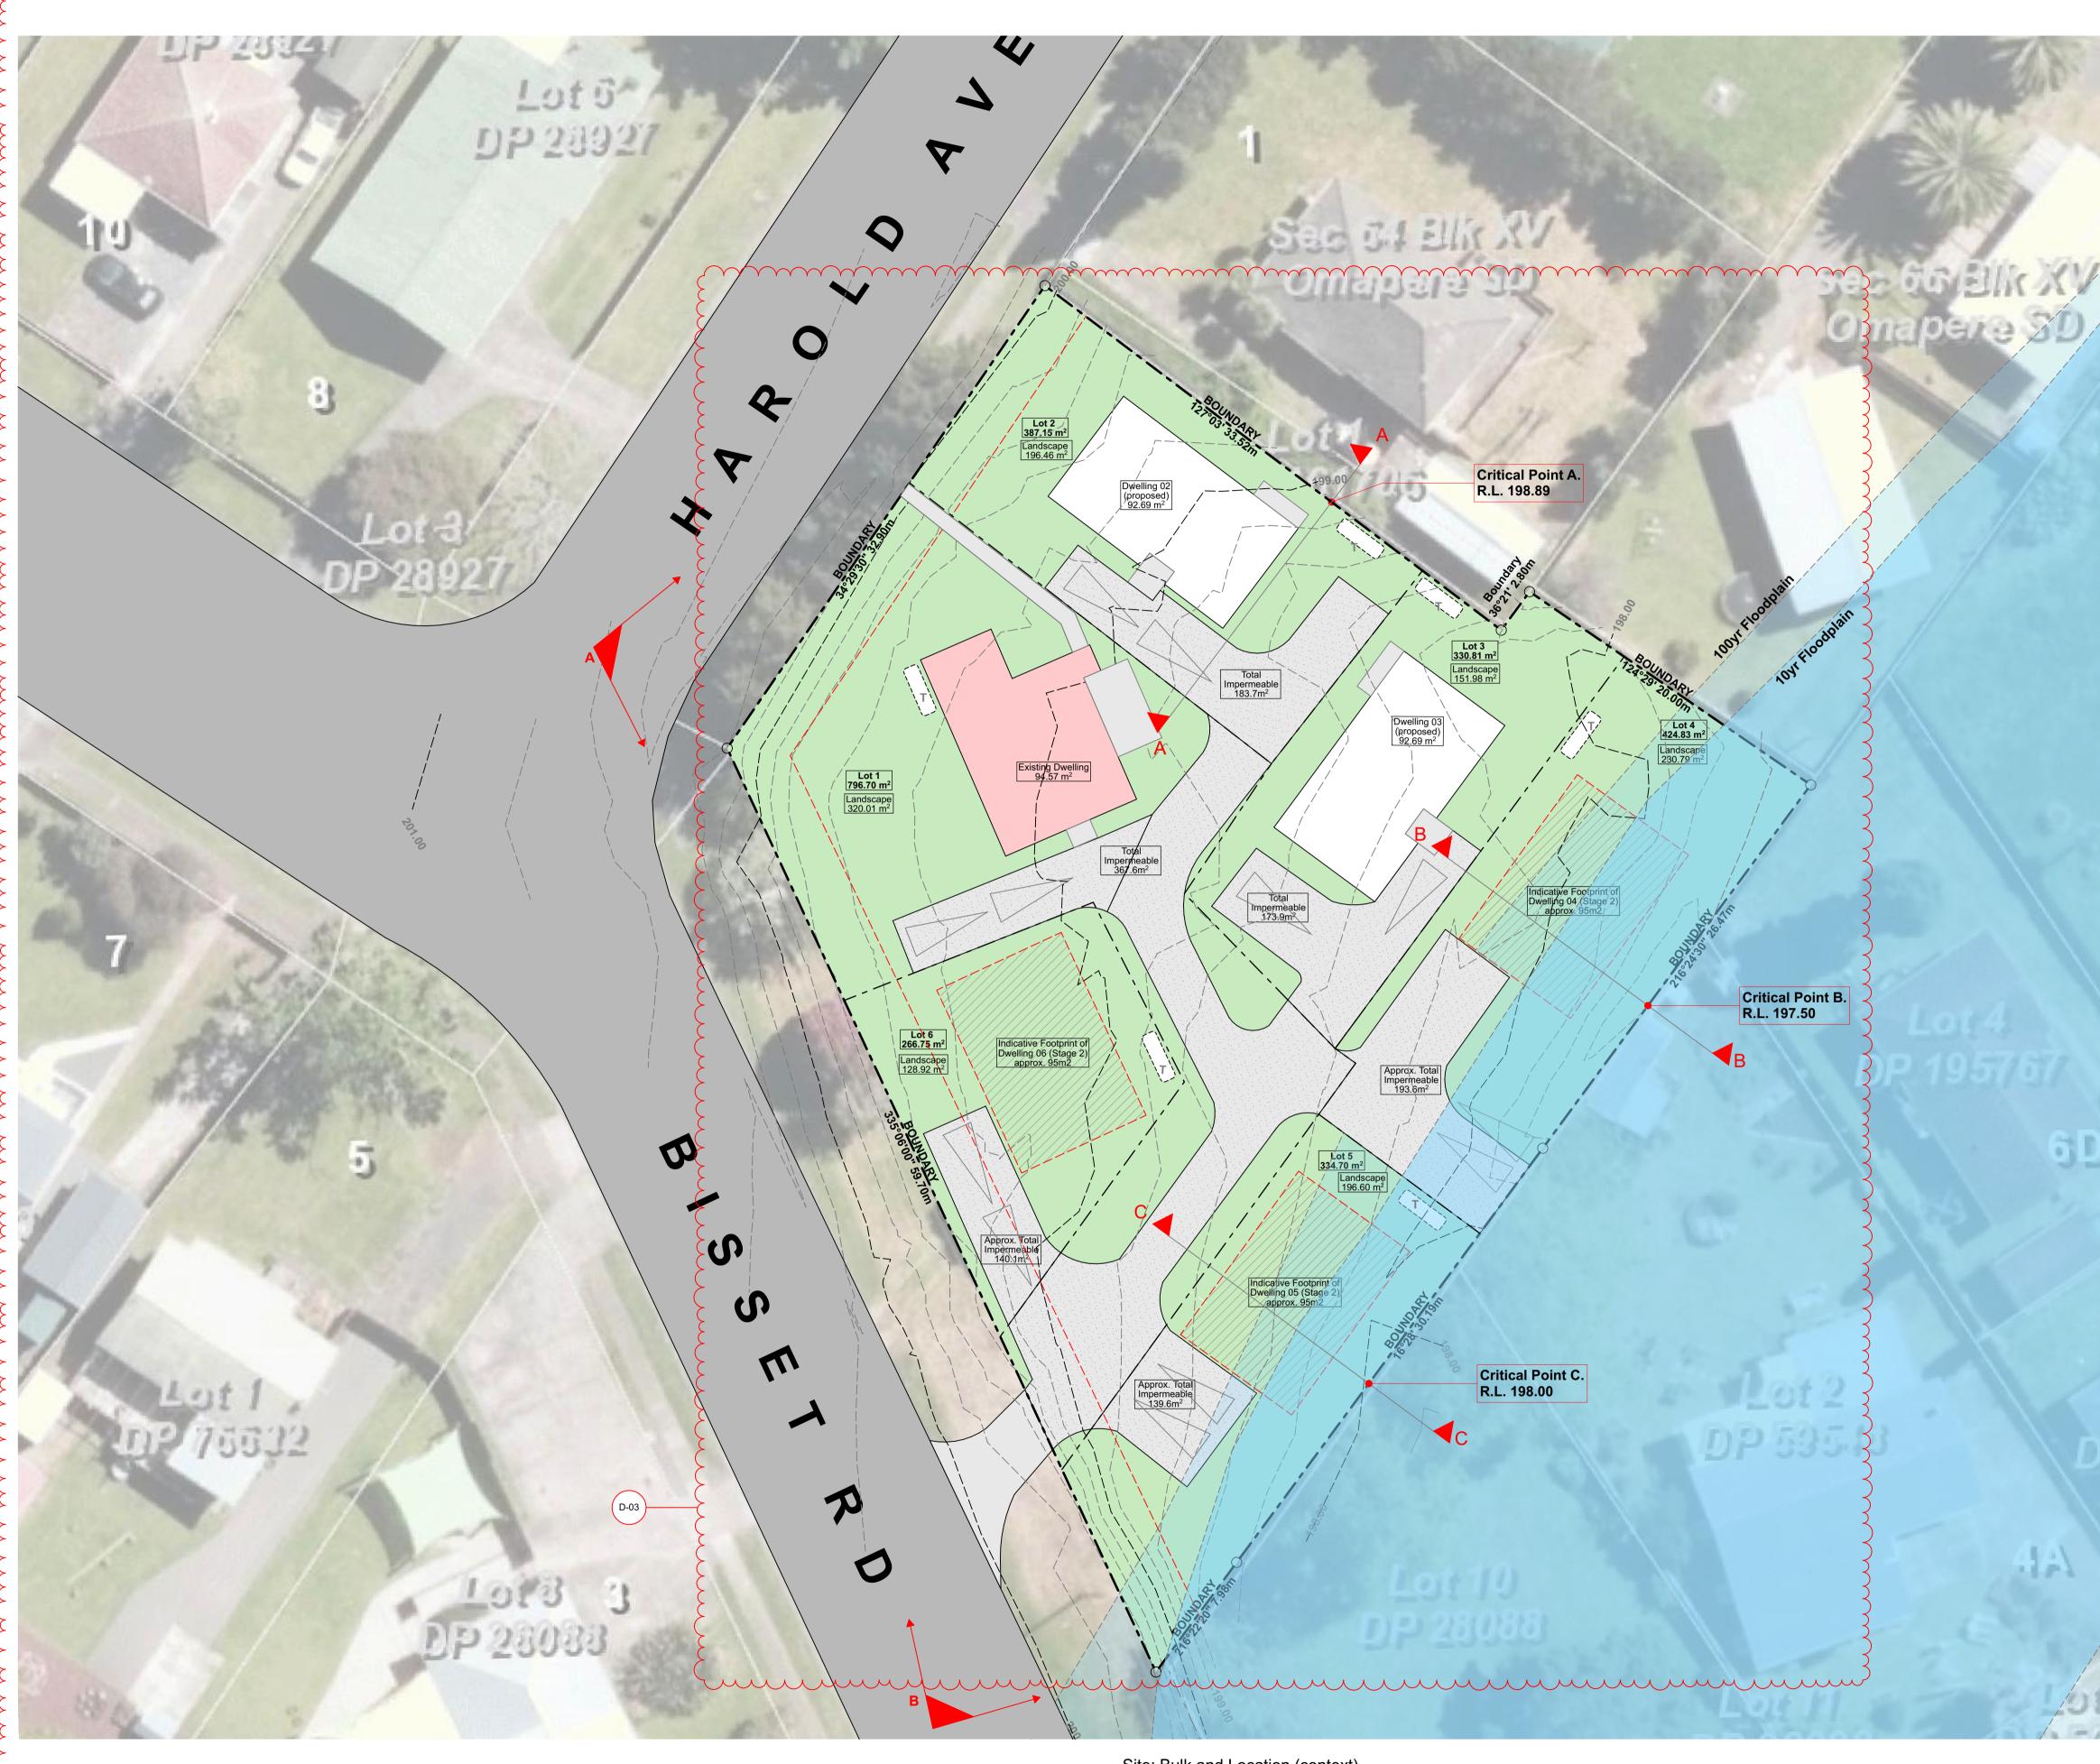

Site: Bulk and Location (context)

**6 BISSET ROAD - AUP COVERAGE CALCULATIONS** 

60

2,541m2

approx. 563m2 approx. 1,206m2

approx. 1,338m2

Site Area

Building Coverage Landscaped Area

						NORTH
UP 23321	Lot 5	1	4		En The	Summed set

## **GENERAL NOTES**

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0.4 If in doubt, consult the Architect.


## **BULK & LOCATION LEGEND:**

Existing residence to remain.
Proposed transportable home (Stage 1).
Landscape (permeable)
Deck/Landing (impermeable)
Gravel / vehicle manoeuvering (impermeable)
Indicative coverage of unconfine transportable houses (Stage 2

(impermeable) Indicative coverage of unconfirmed

transportable houses (Stage 2)

## SITE PLAN LEGEND:

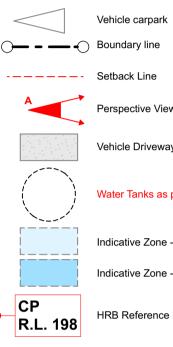

Perspective View Location

Vehicle Driveway

Water Tanks as per engineer design.

Indicative Zone - 100yr flood event

Indicative Zone - 10yr flood event

HRB Reference Point



RevID	ChID	Revision	Date
A			22/07/20
D	D-01	Carriageway updates / boundary adjustments	11/09/20
	D-03	Coverage Calculations updated	

P. 021 250 6671 E. esnempropertiesltd@gmail.com

**Esnem Properties Ltd** 

# **Proposed Subdivision**

6 Bisset Road Kaikohe Northland

sheet title **RC Submission** Site Bulk & Location

drawn ST

1:200

AUP Compliance 22.1% (<45% required) 47.4% (<60% required)

title

scale As marked at A1 sheet no.

**RC03** 


printed Friday, 11 September 2020

issue


D

**Resource Consent** '6 bisset/Archi Files/RC/200911 6 Bisset RC Set\_Issue D.pln

APPROVED PLAN Planner: pkillalea RC: 2300042 Date: 15/09/2020

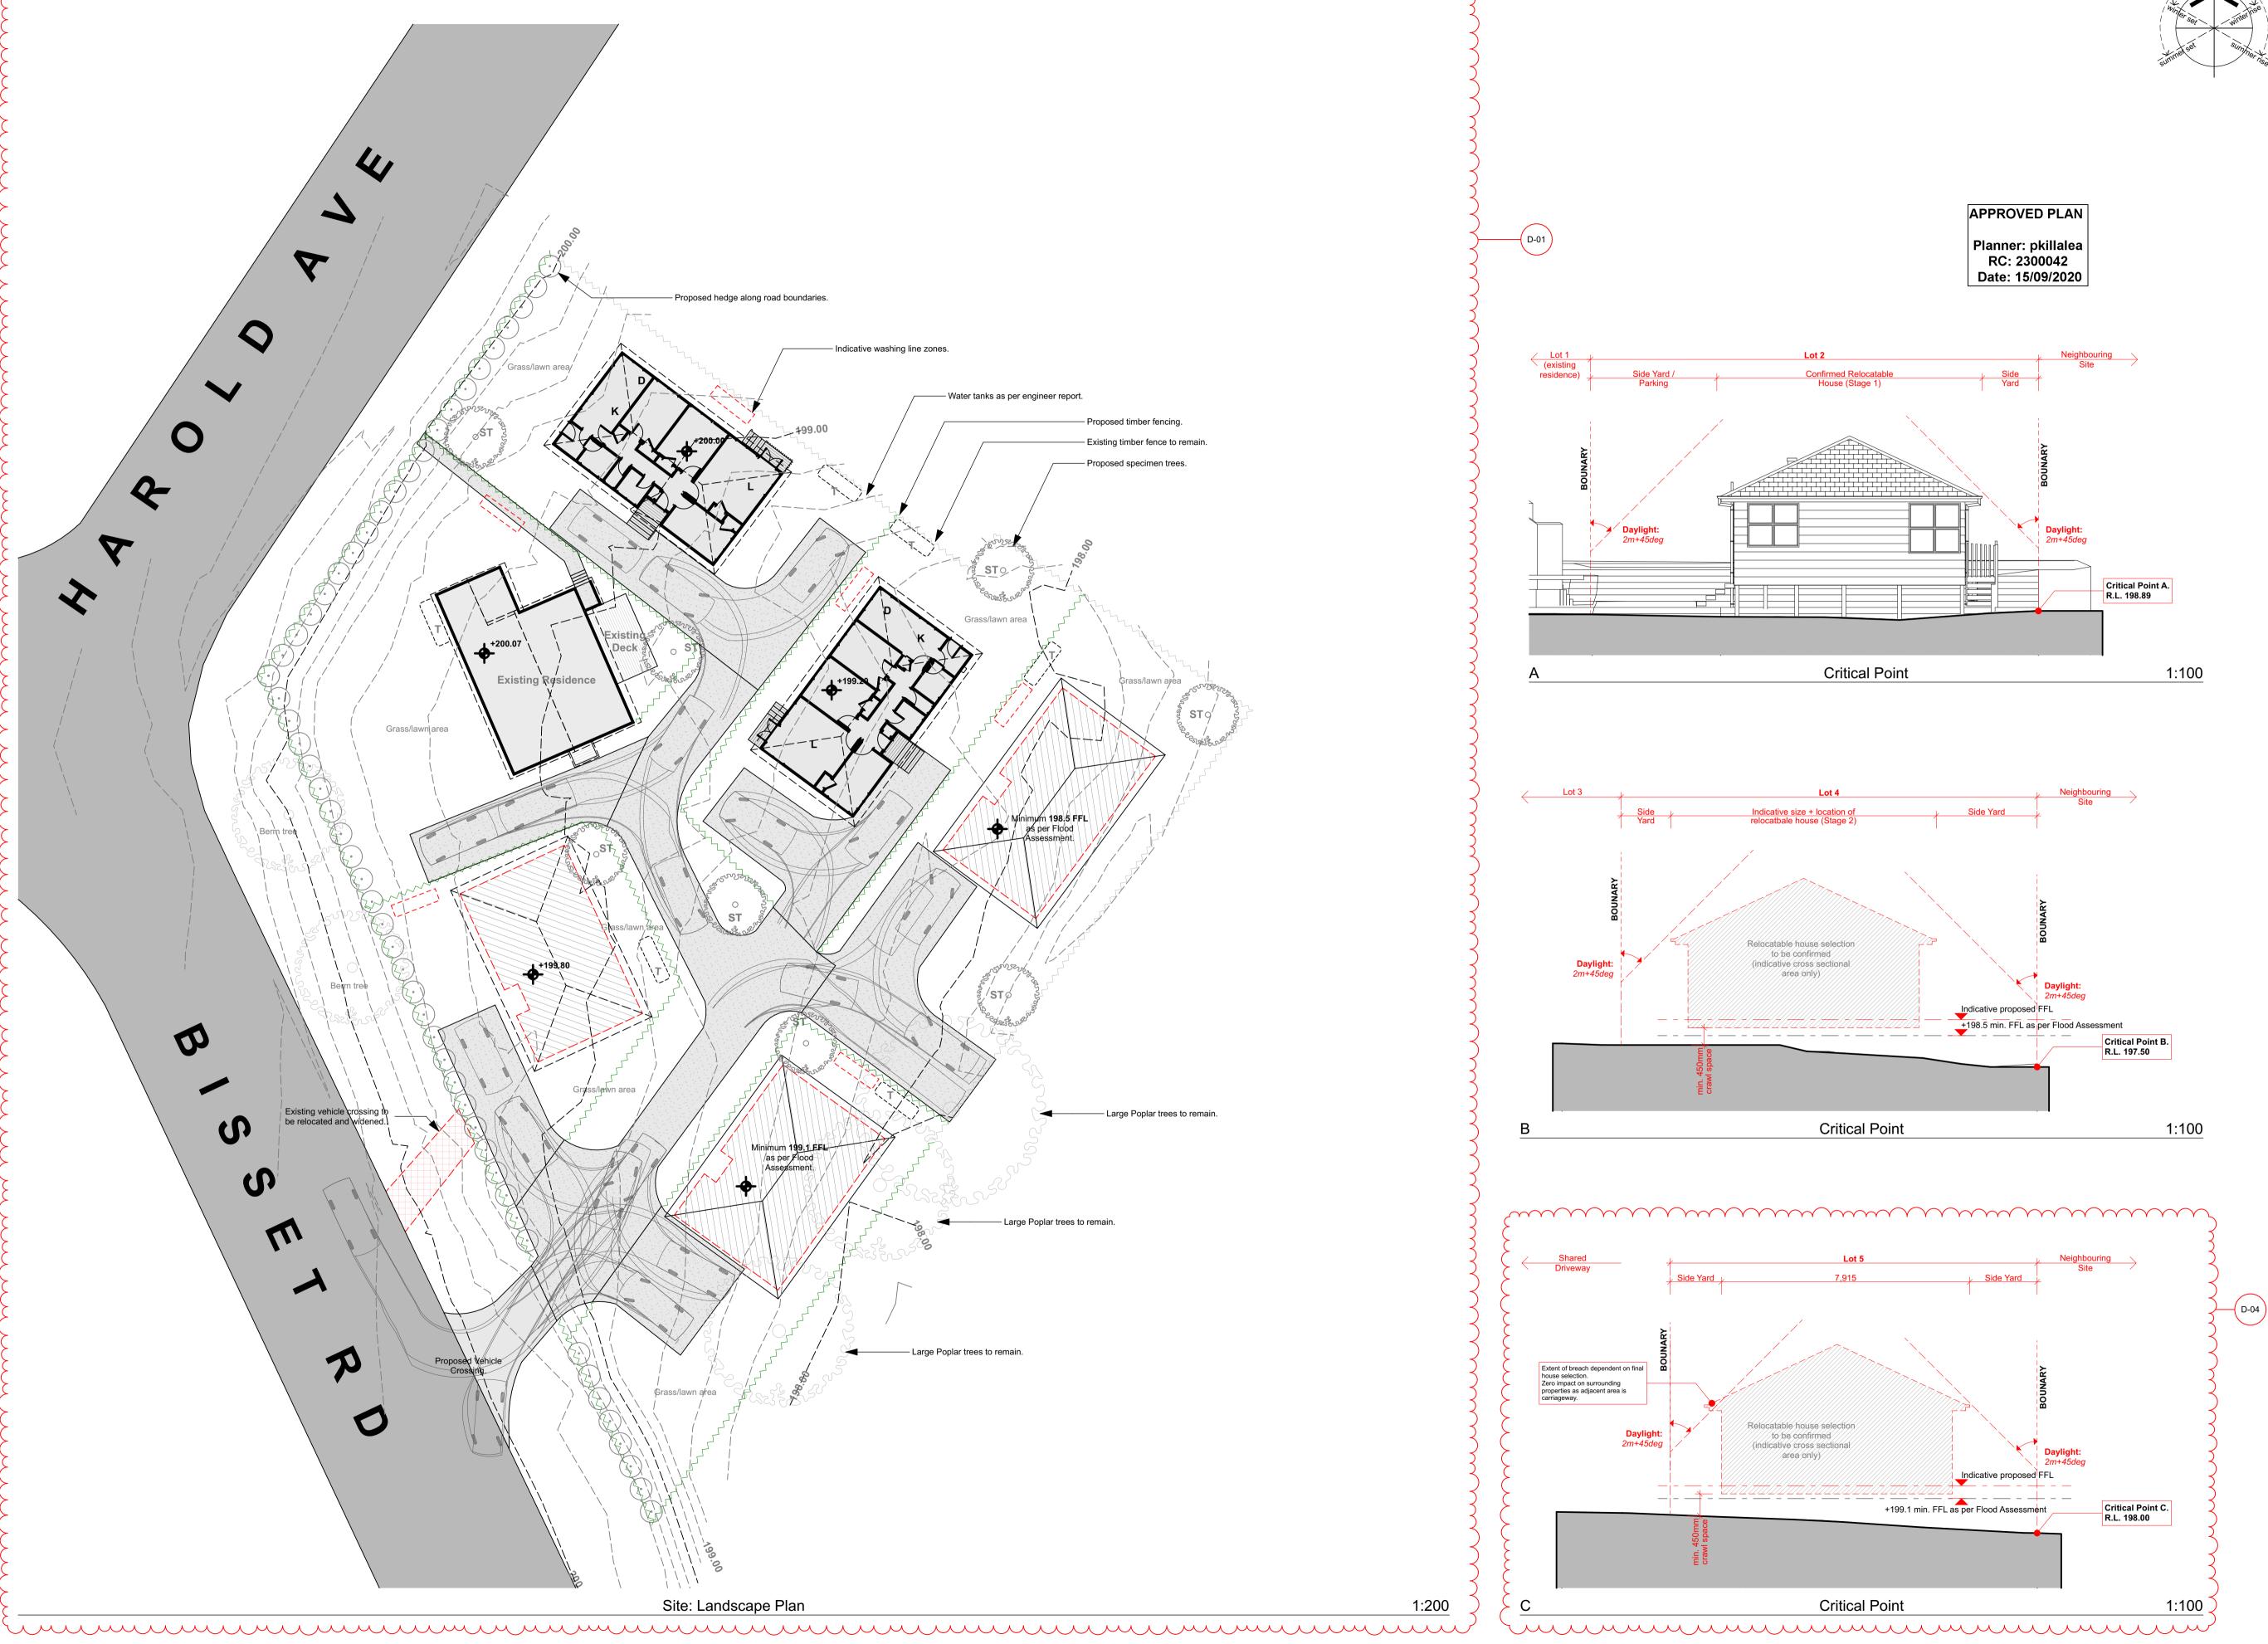

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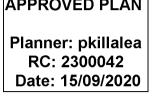

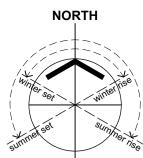
## GENERAL NOTES

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# LANDSCAPE PLAN LEGEND:

	Vehicle Driveway
	5000L Water Tanks as Stormwater Assessment.
ST	Proposed Specimen Tree
•	Proposed pittosporum hedge along road boundaries.
~~~~~	Existing timber fences to remain.
~~~~~	Proposed timber fencing
[[]]]	Indicative washing line zone




RevID		Revision	Date
А			22/07/20
D	D-01	Carriageway updates / boundary adjustments	11/09/20
	D-04	Section C updated	ļ
	1 250 6	6671 opertiesItd@gmail.com	
		opon doond wy man.com	
title			
Esr	nem	Properties Ltd	
-			
Pro	pos	ed Subdivision	
	•	<b>ed Subdivision</b> Road	
6 Bi	isset	Road	
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**RC04** D printed Friday, 11 September 2020

**Resource Consent** '6 bisset/Archi Files/RC/200911 6 Bisset RC Set\_Issue D.pln



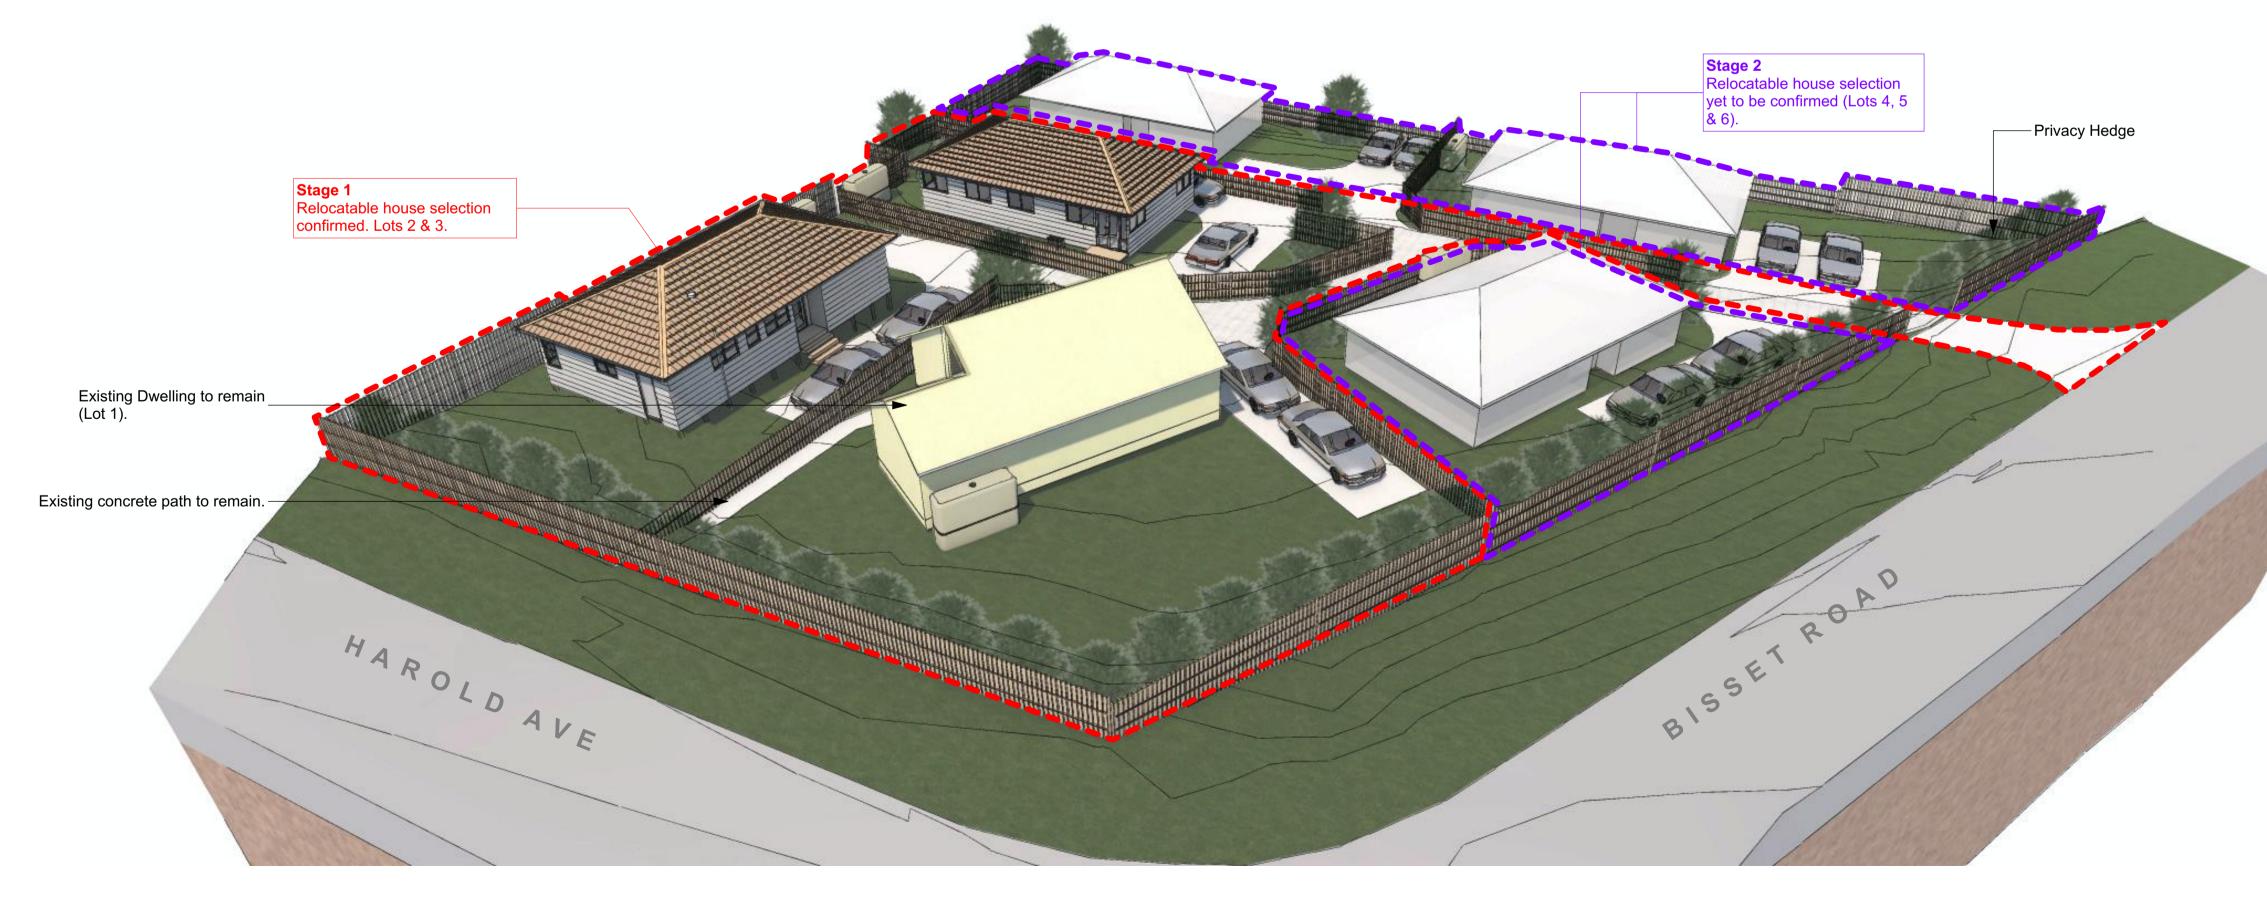

# PERSPECTIVE 'B'


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## **GENERAL NOTES**

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APPROVED PLAN

Planner: pkillalea RC: 2300042 Date: 15/09/2020



P. 021 250 6671 E. esnempropertiesItd@gmail.com

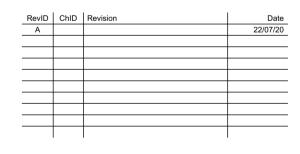title **Esnem Properties Ltd** 

**Proposed Subdivision** 6 Bisset Road Kaikohe

Northland sheet title **RC Submission** 


Perspectives

drawn ST


scale As marked at A1 sheet no.

**RC05** printed Friday, 11 September 2020



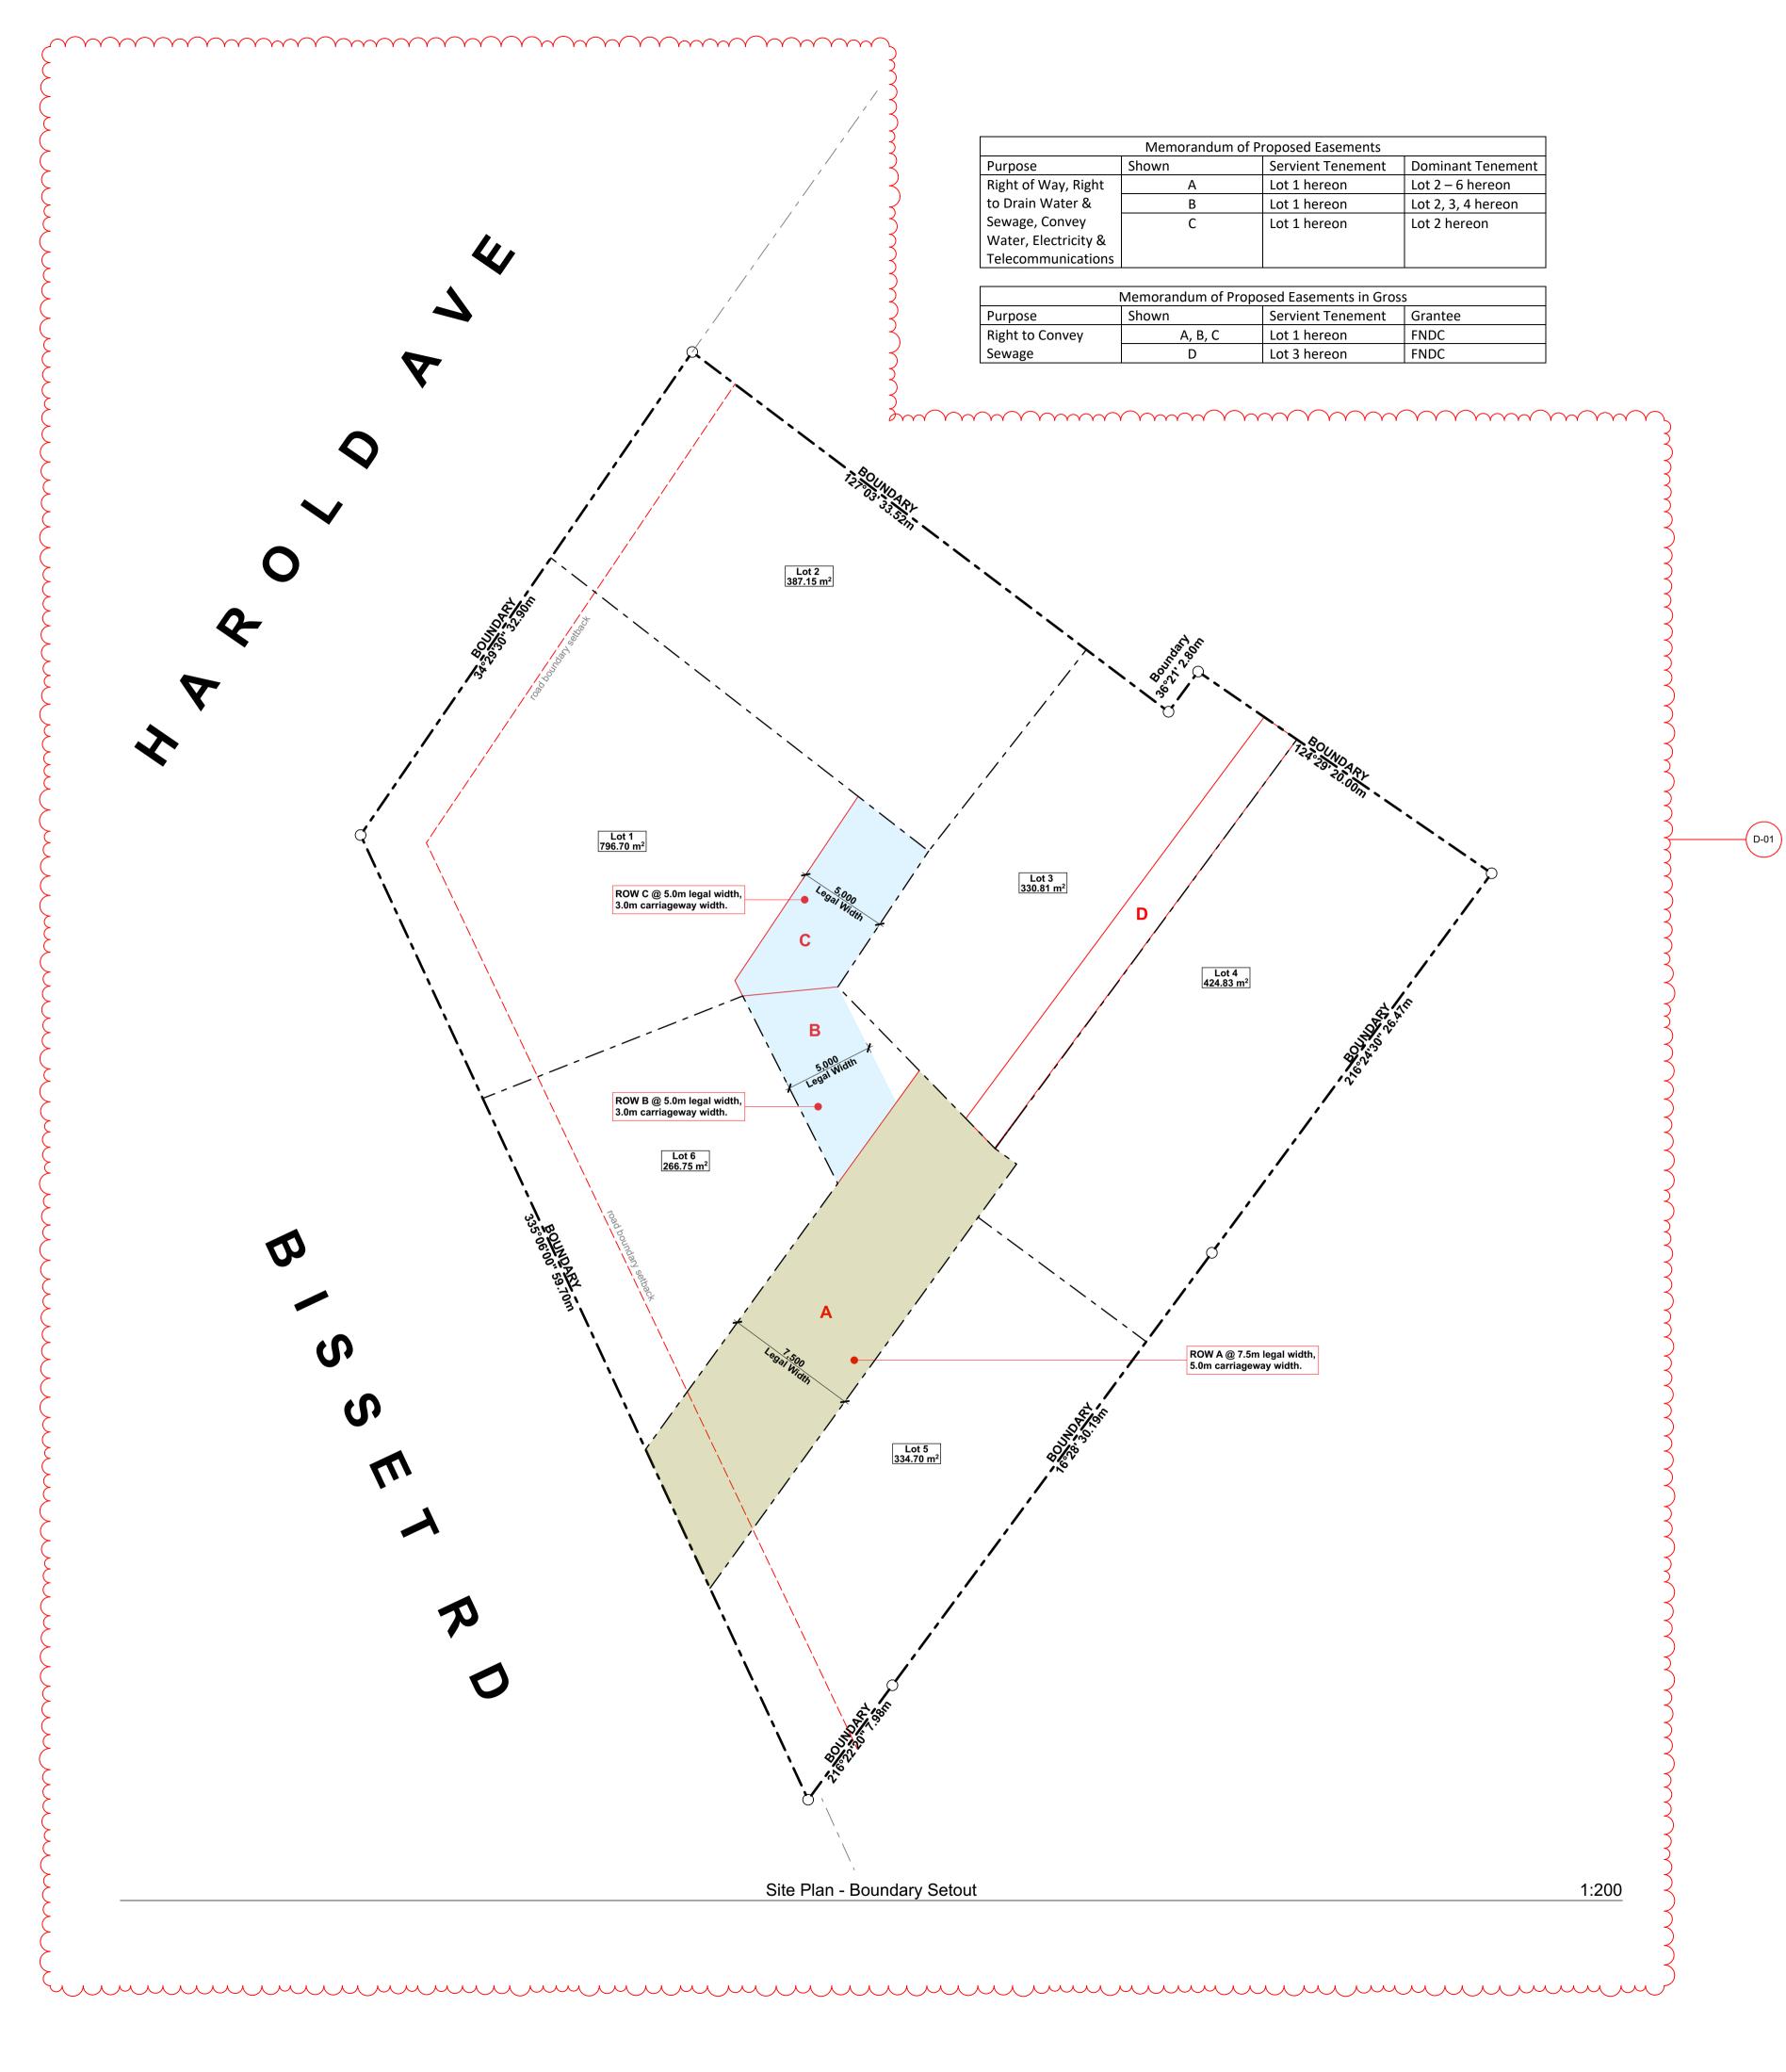

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## GENERAL NOTES
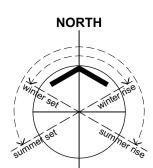
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APPROVED PLAN Planner: pkillalea

RC: 2300042 Date: 15/09/2020

RevID	ChID	Revision	Date
В	B-01	Boundary Setout plan added to set	19/08/20
С	C-01	Easement schedule added	27/08/20
D	D-01	Carriageway updates / boundary adjustments	11/09/20

P. 021 250 6671 E. esnempropertiesItd@gmail.com

title **Esnem Properties Ltd** 

## **Proposed Subdivision** 6 Bisset Road

Kaikohe Northland sheet title

## **RC Submission** Site Plan: Boundary Setout

drawn ST

sheet no.

scale As marked at A1

# **RC06**

printed Friday, 11 September 2020 **Resource Consent** 

'6 bisset/Archi Files/RC/200911 6 Bisset RC Set\_Issue D.pln

issue

D



ESNEM Properties <esnempropertiesItd@gmail.com>

## RC2300042 - SS Line condition report

5 messages

 ESNEM Properties
 24 November 2020 at 07:25

 To: Pat Killalea
 pat.killalea@fndc.govt.nz>, mark.keehn@fndc.govt.nz, Sujeet Tikaram
 Sujeet.Tikaram@fndc.govt.nz>

Morning All,

A thorough inspection of the sanitary sewer line at 6 Bisset Road Kaikohe has now been conducted by Lincoln from Drainlink (report attached). We would like to acknowledge that although the inspection was resisted at first, a major obstruction has been detected which has meant the exercise was not for nothing. We appreciate this condition being put in place by the FNDC.

Please see drop box link which includes:

- Inspection video footage
- · Inspection report
- Obstruction Location Plan

### https://drive.google.com/drive/folders/1alRIbbBVkDT028k6mBiBAcETV8dV8esX?usp=sharing

As has been reported, a large tree root obstruction via a protruding lateral pipe is present in the SS line. It will be best to contact <u>Lincoln Amosa</u> directly to discuss how best to manage the remediation of this obstruction. As this is a council asset and construction/development has not yet begun on site, the remediation of the pipe is required to be managed and funded by the FNDC.

Lincoln Amosa linc@drainlink.co.nz +64272291332

There is a high chance that Drainlink will be engaged to install the new drainage for the development (separate from the obstructed existing SS line) and so it may be advantageous for the FNDC to have Lincoln address the existing line while he is onsite installing the rest of the drainage work, as he is already very familiar with the site and proposed development.

Being a sanitary sewer line – the Health and safety risk of leakage and contamination is highly concerning (it likely is already contaminating the earth) and so it is Lincolns professional opinion that this be addressed in the immediate future. As owners of this tenanted property, we also cannot tolerate the potential of waste leaking into the site and so we would like to work together with the FNDC to remediate this risk in an efficient and timely manner.

Once Lincoln has been contacted, please get back to us with the appropriate course of action to remediate this line. Thank you.

Yours Sincerely,

Mathew Harding Shane Tregidga Directors ESNEM Properties Limited MH:021 0230 6882 ST: 021 250 6671 E: esnempropertiesItd@gmail.com



ESNEM Properties <esnempropertiesltd@gmail.com> 2 December 2020 at 12:48 To: Pat Killalea <pat.killalea@fndc.govt.nz>, mark.keehn@fndc.govt.nz, Sujeet Tikaram <Sujeet.Tikaram@fndc.govt.nz>

Hi All, has there been any movement in regard to the above email?

Thanks

[Quoted text hidden]

Sujeet Tikaram <Sujeet.Tikaram@fndc.govt.nz> To: ESNEM Properties <esnempropertiesltd@gmail.com> 3 December 2020 at 11:24

Hi Shane,

Please see emails below. I understand that the lateral connection to the existing dwelling on site is to be made redundant once the house is removed/relocated.

FNDC will remove and repair the root damage to the main line but the root ingress into the lateral will need to be removed by your drainlayer and the lateral is to be capped off to prevent regrowth.

Cheers

Sujeet



Development Engineer

Infrastructure & Asset Management, Far North District Council | 24-hour Contact Centre 0800 920 029

ddi +6494015376 | m 027 566 1191 | Sujeet.Tikaram@fndc.govt.nz

Website | Facebook | LinkedIn | Careers

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damage they may cause to Council services, including any services not identified on this plan.

Far North District Council | Te Kaunihera o Tai Tokerau Ki Te Raki | Phone: 09 401 5200 | Fax: 09 401 2137 | Email: ask.us@fndc.govt.nz Memorial Avenue, Private Bag 752, Kaikohe 0440, New Zealand

Get it done online at your convenience, visit our website: www.fndc.govt.nz

Please consider the environment before printing this email.

From: Pat Killalea <pat.killalea@fndc.govt.nz> Sent: Thursday, 3 December 2020 11:17 AM To: Sujeet Tikaram <Sujeet.Tikaram@fndc.govt.nz> Subject: FW: RC2300042 - SS Line condition report

Sujeet,

I assume that Mark is saying that the remedial work on the lateral is the responsibility of the developer while Council will fix up the main line

Regards,






From: Mark Keehn <<u>Mark.Keehn@fndc.govt.nz</u>> Sent: Wednesday, 2 December 2020 1:53 PM To: Sujeet Tikaram <<u>Sujeet.Tikaram@fndc.govt.nz</u>>; Pat Killalea <<u>pat.killalea@fndc.govt.nz</u>> Subject: FW: RC2300042 - SS Line condition report

Hi Guys,

I have reviewed the CCTV. The roots coming from the lateral I believe should be the responsibility of the developer to remove. As the new development won't be using that connection as well would FNDC require them to cap that lateral where there won't be an opportunity for the roots to grow back into the pipeline from that lateral connection.

I will raise a RFS with FNW to have the pipeline flushed and rootcut.

Thanks

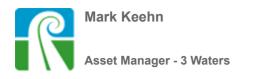

Infrastructure & Asset Management, Far North District Council | 24-hour Contact Centre 0800 920 029

ddi +6494015766 | m +64272328371 | Mark.Keehn@fndc.govt.nz

Website | Facebook | LinkedIn | Careers

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Please consider the environment before printing this email.

**ESNEM Properties** <esnempropertiesltd@gmail.com> To: Sujeet Tikaram <Sujeet.Tikaram@fndc.govt.nz> 8 December 2020 at 21:20

Hi Sujeet,

Thanks for the response.

We understand there are roots coming from the lateral line - or the current 6 bisset connection. You are correct, we will be closing this connection off with the development. However, would it not make sense to treat the roots at the same time while you have the trench open? It seems quite expensive and unnecessary for the FNDC to open the trench up, cut roots and flush, then have us organise a separate drainlayer to come in during this and remove more roots and cap off the connection. The variation in price to cap off our line versus the work that needs to be done would be minimal.

We are happy to fix our connection here - we do have a drainlayer coming to do a lot of work connecting the houses so it would be easy to just add that to the list. We just think for the sake of a minor cost increase, could this not be done at the same time as the other remedial work? That is if you are not replacing the line.

#### Regards,



Sujeet Tikaram <Sujeet.Tikaram@fndc.govt.nz> To: ESNEM Properties <esnempropertiesItd@gmail.com> 9 December 2020 at 07:44

Morning,

Yes, the cost of removing the roots from the sewer lateral are probably minimal, but it depends on the timing of clearing and flushing out of the main line by Council's contractor and when the lateral connection can be capped off.

To be on the safe side, I would suggest that your drainlayer clear the roots from the lateral connection so that all the required works are covered off.

Cheers

Sujeet



Infrastructure & Asset Management, Far North District Council | 24-hour Contact Centre 0800 920 029

ddi +6494015376 | m 027 566 1191 | Sujeet.Tikaram@fndc.govt.nz

Website | Facebook | LinkedIn | Careers

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Please consider the environment before printing this email.

From: ESNEM Properties <esnempropertiesItd@gmail.com> Sent: Tuesday, 8 December 2020 9:21 PM To: Sujeet Tikaram <Sujeet.Tikaram@fndc.govt.nz> Subject: Re: FW: RC2300042 - SS Line condition report Thanks for the response.

We understand there are roots coming from the lateral line - or the current 6 bisset connection. You are correct, we will be closing this connection off with the development. However, would it not make sense to treat the roots at the same time while you have the trench open? It seems quite expensive and unnecessary for the FNDC to open the trench up, cut roots and flush, then have us organise a separate drainlayer to come in during this and remove more roots and cap off the connection. The variation in price to cap off our line versus the work that needs to be done would be minimal.

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Regards,

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	N S	lathew Harding hane Tregidga
	D	irectors∥ESNEM Properties Limited

0/2022, 09:38	Gmail - RC2300042 - SS Line condition report
MH:021 0230 6882	
ST: 021 250 6671	
E: esnempropertiesItd@gmail.com	
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Get it done online at your convenience, visit our website	- www.fndc.govt.nz
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Ph. 09 401 5200   Fax. 09 401 2137   Email. ask.us@fnd	ic.govt.nz
Address. Memorial Avenue, Private Bag 752, Kaikohe 04	40, New Zealand
Please consider the environment before printing this ema	ail.
Yours Sincerely,	
Mathew Harding	
Shane Tregidga	
Directors    ESNEM Properties Limited	
MH:021 0230 6882	
ST: 021 250 6671	
E: esnempropertiesItd@gmail.com	
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## Chorus New Zealand Limited

29 November 2022

Chorus reference: 10301600

Attention: ESNEM PROPERTIES LIMITED

#### Chorus clearance letter for development reticulation of Chorus network

#### 2 connections at 6 Bisset Road , Kaikohe, Far North District, 0405

#### Project: 6 Bisset Road, Kaikohe 0405, Stage 1

We can confirm that satisfactory works have been undertaken to enable the provision of a connected service to the Chorus network for the above development.

This assessment is based on the scheme plan and Land Title plan submitted to Chorus. We note that any required easements may still need to be lodged.

This letter does not cover service lead-ins to individual premises. New occupants will need to contact their chosen internet provider to order a service after 29 November 2022, at which time a service lead-in will be provisioned as required.

Kind Regards

Chorus New Property Development Team





Top Energy Limited

8 July 2022

Level 2, John Butler Centre 60 Kerikeri Road P O Box 43 Kerikeri 0245 New Zealand PH +64 (0)9 401 5440 FAX +64 (0)9 407 0611

Mathew Harding Esnem Properties Ltd

Email: <a>esnempropertiesltd@gmail.com</a>

To Whom It May Concern:

### RE: COMPLETION RC-2300042-RMACOM Esnem Properties Ltd – 6 Bisset Road, Kaikohe. Lot 2 DP 1611706.

Thank you for your recent correspondence with attached proposed subdivision scheme plans.

Top Energy wish to advise that the sub divider has made provision for electricity as per conditions of Resource Consent Number: 2300042-RMACOM section 4(m).

If you have any further queries, please do not hesitate to contact the writer.

Yours sincerely

Aaron Birt Planning and Design T: 09 407 0685 E: aaron.birt@topenergy.co.nz



**TOP ENERGY RESPONSIBILITY** 

LVUG - Road Reserve - Thrust/install duct and LVUG cable (4c/185mm/AL/XPLE) approx 70m from pillar 820881 on Harold Ave to entrance on Bisset Rd (J1 location shown on plan).

Pillar Install - Install an EP3 pillar at J1 location.

**Connection** - Provide a 1ph 63A per phase fused connection point at pillar J1. Connect service main cable (installed by others) to the above connection point.

Final Inspection - Inspect, test and liven new connection.

## **CUSTOMER RESPONSIBILITY**

Service Main Cable - Customer to arrange their preferred electrical contractor to supply/install the LV UG service main cable from the new pillar to the proposed new meter location.


## **NOTES:**

verification. **SAP Work Orders** 

```
(CF) 40067288 - Connection Fee
(CAPC/LV) 40067289 - LVUG Road Reserve/ Pillar Install
(QUOTE) 20005267
```

## **REFERENCE DRAWINGS**

10UO-0500-1 Trench Profile

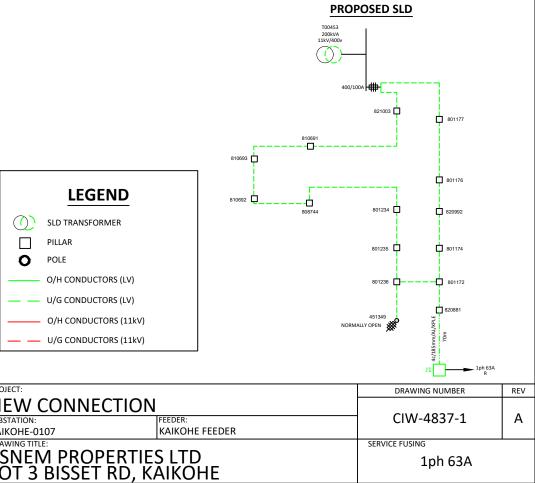

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								Level 2 John Butler Centre 📩	Ph: 09 401 5440			ESNEM PROPERTIES
								60 Kerikeri Road, Kerikeri	Fax: 09 401 5605	CULET A		LOT 2 DICCET DD VA
C:\V	AULTWS\DESIGNS\TE DRAWINGS\03 - PROJECTS\ANDREA\4837-ESNEM\CIW-4837-1.DWG							PO Box 43, Kerikeri 0245	www.topenergy.co.nz	SHEET 1	OF 1	LOT 3 BISSET RD, KA

## **CONSTRUCTION DETAILS**

Possible land base inaccuracies. Property boundaries and Top Energy asset locations shown on the plan are an indication only and are subject to onsite